

GENERAL NOTES:

- 1. NEW HANOVER COUNTY PARCEL NUMBERS: PID R04809-033-004-000
- PID R04809-033-004-000 2. TOTAL PROJECT AREA: 30,714 SF (0.71 AC)
- 3. EXISTING ZONING DISTRICT: CBD
- 4. CAMA LAND CLASSIFICATION: URBAN
- 5. THIS SITE IS LOCATED WITHIN ZONE "X" ACCORDING TO FEMA FIRM COMMUNITY PANEL NUMBER 3720311800L, EFFECTIVE DATE
- 6. SITE ADDRESS: 1010 N. 4TH ST.7. BOUNDARY AND TOPOGRAPHIC SURVEY PERFORMED AND PROVIDED
- 7. BOUNDARY AND TOPOGRAPHIC SURVEY PERFORMED AND PROVIDE TO CSD ENGINEERING BY HANOVER DESIGN SERVICES; VERTICAL
- DATUM = 88 8. NO WETLANDS LOCATED ONSITE
- 9. STORMWATER DRAINS TO NE CAPE FEAR RIVER, SC; Sw 18-74-(61)
 10. LAND OWNER 1010 NORTH FOURTH STREET, LLC

82 HANOVER STREET PORTLAND, ME 04101—1979


LEGEND EXISTING BOUNDARY EXISTING WATERLINE — PROPOSED LOTLINE PROPOSED WATERLINE CENTERLINE OF RIGHT OF WAY CONTOUR LINE & ELEVATION EXISTING / PROPOSED STORM SEWER & CATCH BASIN DRAINAGE FLOW EXIST. IRON PIPE 30' DRAINAGE EASEMENT WATER METER SERVICE CONNECTION EXIST. CONCRETE MONUMENT PROPOSED DRAINAGE PIPE GATE VALVE PROPOSED SANITARY REDUCER (S)——SS ——— SEWER & MANHOLE HANDICAP RAMP EXISTING SANITARY SEWER & MANHOLE

OWNER:

1010 NORTH FOURTH STREET, LLC 82 HANOVER STREET PORTLAND, ME 04101-1979 CONSTRUCTION DRAWINGS for

THE HELM

LOCATED IN CITY OF WILMINGTON
NEW HANOVER COUNTY, NORTH CAROLINA

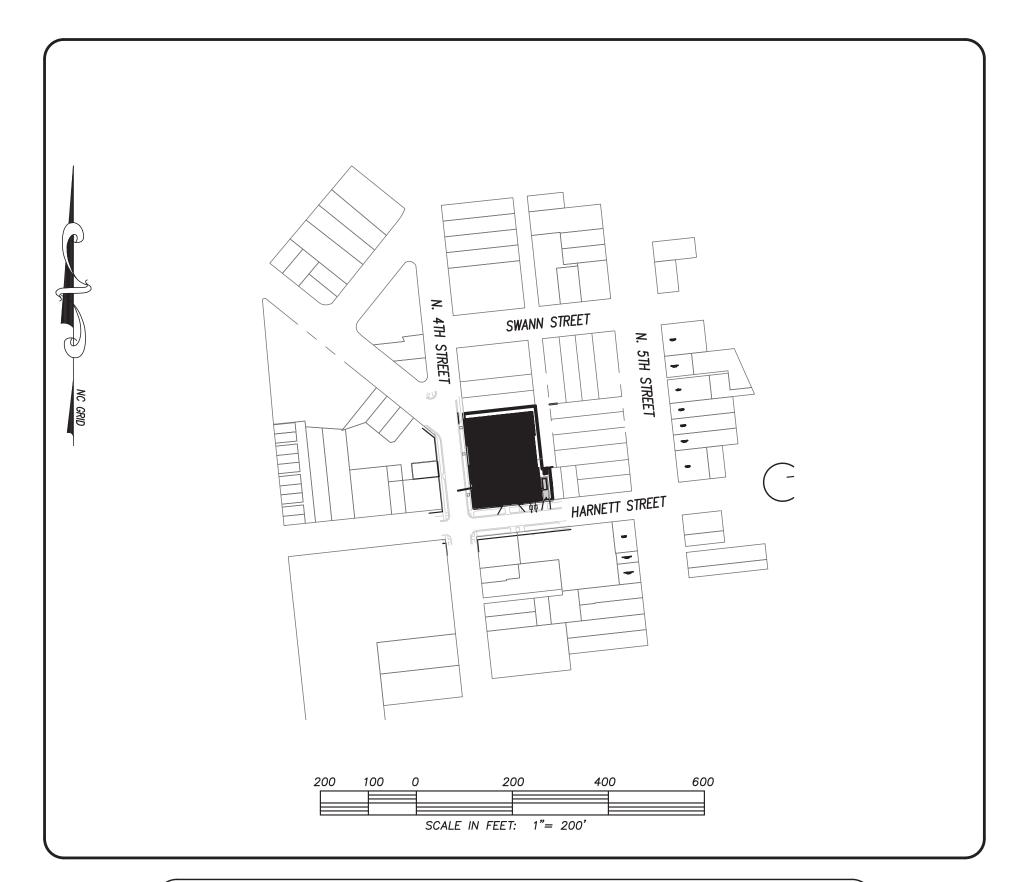

	INDEX TO DRAWINGS	
SHEET No.	DESCRIPTION	DRAWING No.
1 OF 9	COVER SHEET	CD_COVER
2 OF 9	EXISTING BOUNDARY AND TOPOGRAPHY AND TREE SURVEY	EX-COND
3 OF 9	SITE PLAN	SITE_PLAN
4 OF 9	GRADING AND STORMWATER PLAN	GP
5 OF 9	SITE DETAILS	SITE_DETAILS_1
6 OF 9	SITE DETAILS	SITE_DETAILS_2
7 OF 9	LANDSCAPE PLAN	LP
8 OF 9	CFPUA DETAILS	CFPUA
9 OF 9	CFPUA DETAILS	CFPUA)

NOTES:

- 1. ASBUILT, BOUNDARY AND TOPOGRAPHIC SURVEY PERFORMED AND PROVIDED TO CSD ENGINEERING BY TO CSD ENGINEERING BY HANOVER DESIGN SERVICES; VERTICAL DATUM = 88
- 2. THIS MAP IS NOT FOR CONVEYANCE, RECORDATION, OR SALES.
- 3. THIS PROPERTY IS LOCATED WITHIN ZONE "X"

 ACCORDING TO THE FEMA FLOOD INSURANCE RATE MAP,

 3720311800L, EFFECTIVE DATE 8/28/18
- 4. EXISTING ZONING: CBD
- 5. CFPUA WATER
- 6. CFPUA SEWER
- 7. ALL CONSTRUCTION TO CONFORM TO CITY OF WILMINGTON STANDARDS AND APPLICABLE STATE & LOCAL CODES.
- 8. CONTRACTOR TO COORDINATE ANY REQUIRED TRAFFIC CONTROL WITH CITY OF WILMINGTON AND OR NCDOT.
- 9. CARE SHALL BE TAKEN DURING FINAL GRADING TO ENSURE POSITIVE DRAINAGE AWAY FROM BUILDINGS AND TO RECEIVING STRUCTURES.
 ROOF DRAIN DOWNSPOUTS TO BE CONNECTED TO STORM DRAINAGE

STUBOUTS OR DIRECTED TO STREET/PARKING AREAS.

- 10. CONTRACTOR IS RESPONSIBLE FOR COORDINATION OF ANY RELOCATIONS, RE-ALIGNMENTS, DISCONNECTIONS OR CONNECTIONS OF EXISTING UTILITIES WITH APPLICABLE AUTHORITIES.
- 11. CLEARING AND GRUBBING OF SITE TO INCLUDE REMOVAL OF EXISTING CURB, ASPHALT, INLETS, AND ANY OTHER STRUCTURES INCLUDING TREES, STUMPS AND DEBRIS EXISTING ON SITE. TREES NOT REQUIRED TO BE CLEARED FOR CONSTRUCTION SHALL REMAIN UNLESS OTHERWISE DIRECTED.
- 12. INFORMATION CONCERNING UNDERGROUND UTILITIES WAS OBTAINED FROM AVAILABLE RECORDS. IT SHALL BE THE RESPONSIBILITY OF THE CONTRACTOR TO DETERMINE THE EXACT ELEVATIONS AND LOCATIONS OF ALL EXISTING UTILITIES AT ALL CROSSINGS PRIOR TO COMMENCING TRENCH EXCAVATION. IF ACTUAL CLEARANCES ARE LESS THAN INDICATED ON PLAN, THE CONTRACTOR SHALL CONTACT THE DESIGN ENGINEER BEFORE PROCEEDING WITH CONSTRUCTION. ANY CONDITION DISCOVERED OR EXISTING THAT WOULD NECESSITATE A MODIFICATION OF THESE PLANS SHALL BE BROUGHT TO THE ATTENTION OF THE DESIGN ENGINEER BEFORE PROCEEDING WITH CONSTRUCTION.
- 13. NO CONSTRUCTION IS TO BEGIN BEFORE LOCATION OF EXISTING
 UTILITIES HAS BEEN DETERMINED. CALL "NC ONE—CALL" AT LEAST
 72 HOURS BEFORE COMMENCING CONSTRUCTION.
- 14. CONTRACTOR SHALL ADJUST ALL MANHOLES, VALVE & CURB BOXES TO FINAL GRADE UPON COMPLETION OF ALL CONSTRUCTION. ANY BOXES DAMAGED OR OTHERWISE DISTURBED BY THE CONTRACTOR SHALL BE REPAIRED AT THE EXPENSE OF THE CONTRACTOR.
- 15. THE CONTRACTOR IS RESPONSIBLE FOR CONTROLLING DUST AND EROSION DURING CONSTRUCTION AT HIS EXPENSE. PARKING AREAS SHALL BE WATERED TO CONTROL DUST WHEN ORDERED BY THE ENGINEER.
- WATERED TO CONTROL DOST WHEN ORDERED BY THE ENGINEER.

 16. NO GEOTECHNICAL TESTING HAS BEEN PERFORMED ON SITE. NO
 WARRANTY IS MADE FOR SUITABILITY OF SUBGRADE, AND UNDERCUT
 AND ANY REQUIRED REPLACEMENT WITH SUITABLE MATERIAL SHALL
 BE THE RESPONSIBILITY OF THE CONTRACTOR.
- 17. CONTRACTOR TO ENSURE THAT PAVEMENT IS PLACED SO AS TO DRAIN POSITIVELY TO THE STREET INLETS AND CATCH BASINS. ALL FUTURE ROOF DRAIN DOWNSPOUTS TO BE DIRECTED TO THE STORM DRAINAGE STUBOUTS.
- 18. CONTRACTOR IS RESPONSIBLE FOR OBTAINING ALL REQUIRED PERMITS.
- 19. THIS PLAN IS FOR SITE GRADING, UTILITIES, SITING, AND DRAINAGE ONLY. SEE BUILDING PLANS FOR DETAILED HOOKUPS TO BUILDINGS, ETC.
- 20. CONTRACTOR AND BUILDER ARE RESPONSIBLE FOR COORDINATING
 FINISHED FLOOR ELEVATION OF ALL BUILDINGS WITH THE OWNER. ELEVATIONS
 GIVEN ARE MINIMUM GROUND ELEVATIONS AT THE BUILDING SITE AND DO NOT
 PURPORT TO BE FINISHED FLOOR. MINIMUM RECOMMENDED FF ELEVATIONS
 SHOWN ON PLANS.
- 21. AFFECTED NON-MUNICIPAL UTILITIES SHALL BE CONTACTED AND PROVIDED WITH PLANS AND OTHER PERTINENT INFORMATION, WHEN FEASIBLE, TO COORDINATE APPROPRIATE SCHEDULING AND PLACEMENT.
- COORDINATE APPROPRIATE SCHEDULING AND PLACEMENT.

 22. EXTREME CARE SHALL BE TAKEN TO ENSURE MINIMUM SEPARATIONS
 AT ALL UTILITY CROSSINGS.
- 23. MINIMUM SEPARATION SHALL BE MAINTAINED AS FOLLOWS:

 a. HORIZONTAL SEPARATION OF 10 FEET BETWEEN SANITARY SEWER AND
 WATER MAINS AND STORM SEWER.
 - b. WHERE VERTICAL CLEARANCE IS LESS THAN 24" BETWEEN SANITARY SEWER AND WATER OR WHERE SEWER LINE CROSSES ABOVE WATER MAIN, BOTH PIPES SHALL BE DUCTILE IRON PIPE FOR A MINIMUM OF 10' EITHER SIDE OF CROSSING.
 - c. WHERE VERTICAL CLEARANCE IS LESS THAN 24" BETWEEN SANITARY SEWER AND STORM DRAIN, SANITARY SEWER SHALL BE DUCTILE IRON PIPE FOR A MINIMUM OF 10 FEET EITHER SIDE OF CROSSING.
 - d. WHERE VERTICAL CLEARANCE IS LESS THAN 12" BETWEEN SANITARY
 SEWER AND STORM DRAIN, SANITARY SEWER SHALL BE DUCTILE IRON
 PIPE FOR A MINIMUM OF 10' EITHER SIDE OF CROSSING, AND BRIDGING
 SHALL BE INSTALLED PER APPLICABLE UTILITY AUTHORITY'S DETAILS.
 e. IN NO CASE SHALL THERE BE LESS THAN 18" OF SEPARATION BETWEEN
 - OUTSIDE OF WATER MAIN AND OUTSIDE OF SEWER OR STORM DRAINAGE.

 f. MINIMUM COVER OF 36" SHALL BE PROVIDED FOR ALL BURIED WATER
 MAINS AND SANITARY SEWER MAINS.
- 24. SEE DETAIL SHEETS FOR TYPICAL UTILITIES HOOKUPS.
- 25. ALL SANITARY SEWER MAINS TO BE 8" UNLESS OTHERWISE INDICATED.
- 26. ALL WATER MAINS TO BE 8" UNLESS OTHERWISE INDICATED.
- THE WATER LINE TO FIRE HYDRANTS.

 28. A BLOW-OFF VALVE IS REQUIRED AT THE TERMINUS OF ALL "DEAD END"

27. TWO VALVES ARE REQUIRED AT "T" INTERSECTIONS AND ONE VALVE ON

A BLOW-OFF VALVE IS REQUIRED AT THE TERMINUS OF ALL "DEAD END WATER LINES.

(S) CSD ENGINEERING

LICENSE # C-2710

ENGINEERING

LAND PLANNING

COMMERCIAL / RESIDENTIAL

P.O. BOX 4041 WILMINGTON, NC 28406 (910) 791-4441

ENONEERING, with all rights reserved. The use of this document, the Engineer is strictly prohibited. Reproductions, additions, and, the Engineer. Copies of this document must cover from the origin

This document is copyrighted by CSD ENGNEERING, with all rig part of it, without written consent by the Engineer is strictly y must be performed or authorized by the Engineer. Capies of containing the original seal and signature of the Engineer, unit

HANOVER COUNTY, NORTH CA R: 1010 NORTH FOURTH STREE 82 HANOVER STREET PORTLAND, ME 04101—1979

PRELIMINARY

NOT RELEASED

FOR CONSTRUCTION

SED PER BUILDING CHANGES, TRC COMMENTS RLW 10-3-22
REMARKS BY DATE

DATE: 7−25−22


HORZ. SCALE: 1" = 200' VERT. SCALE: N/A DRAWN BY: RLW

CHECKED BY: HSR

PROJECT NO.: 22-0595

Sheet No. _____ Of ____



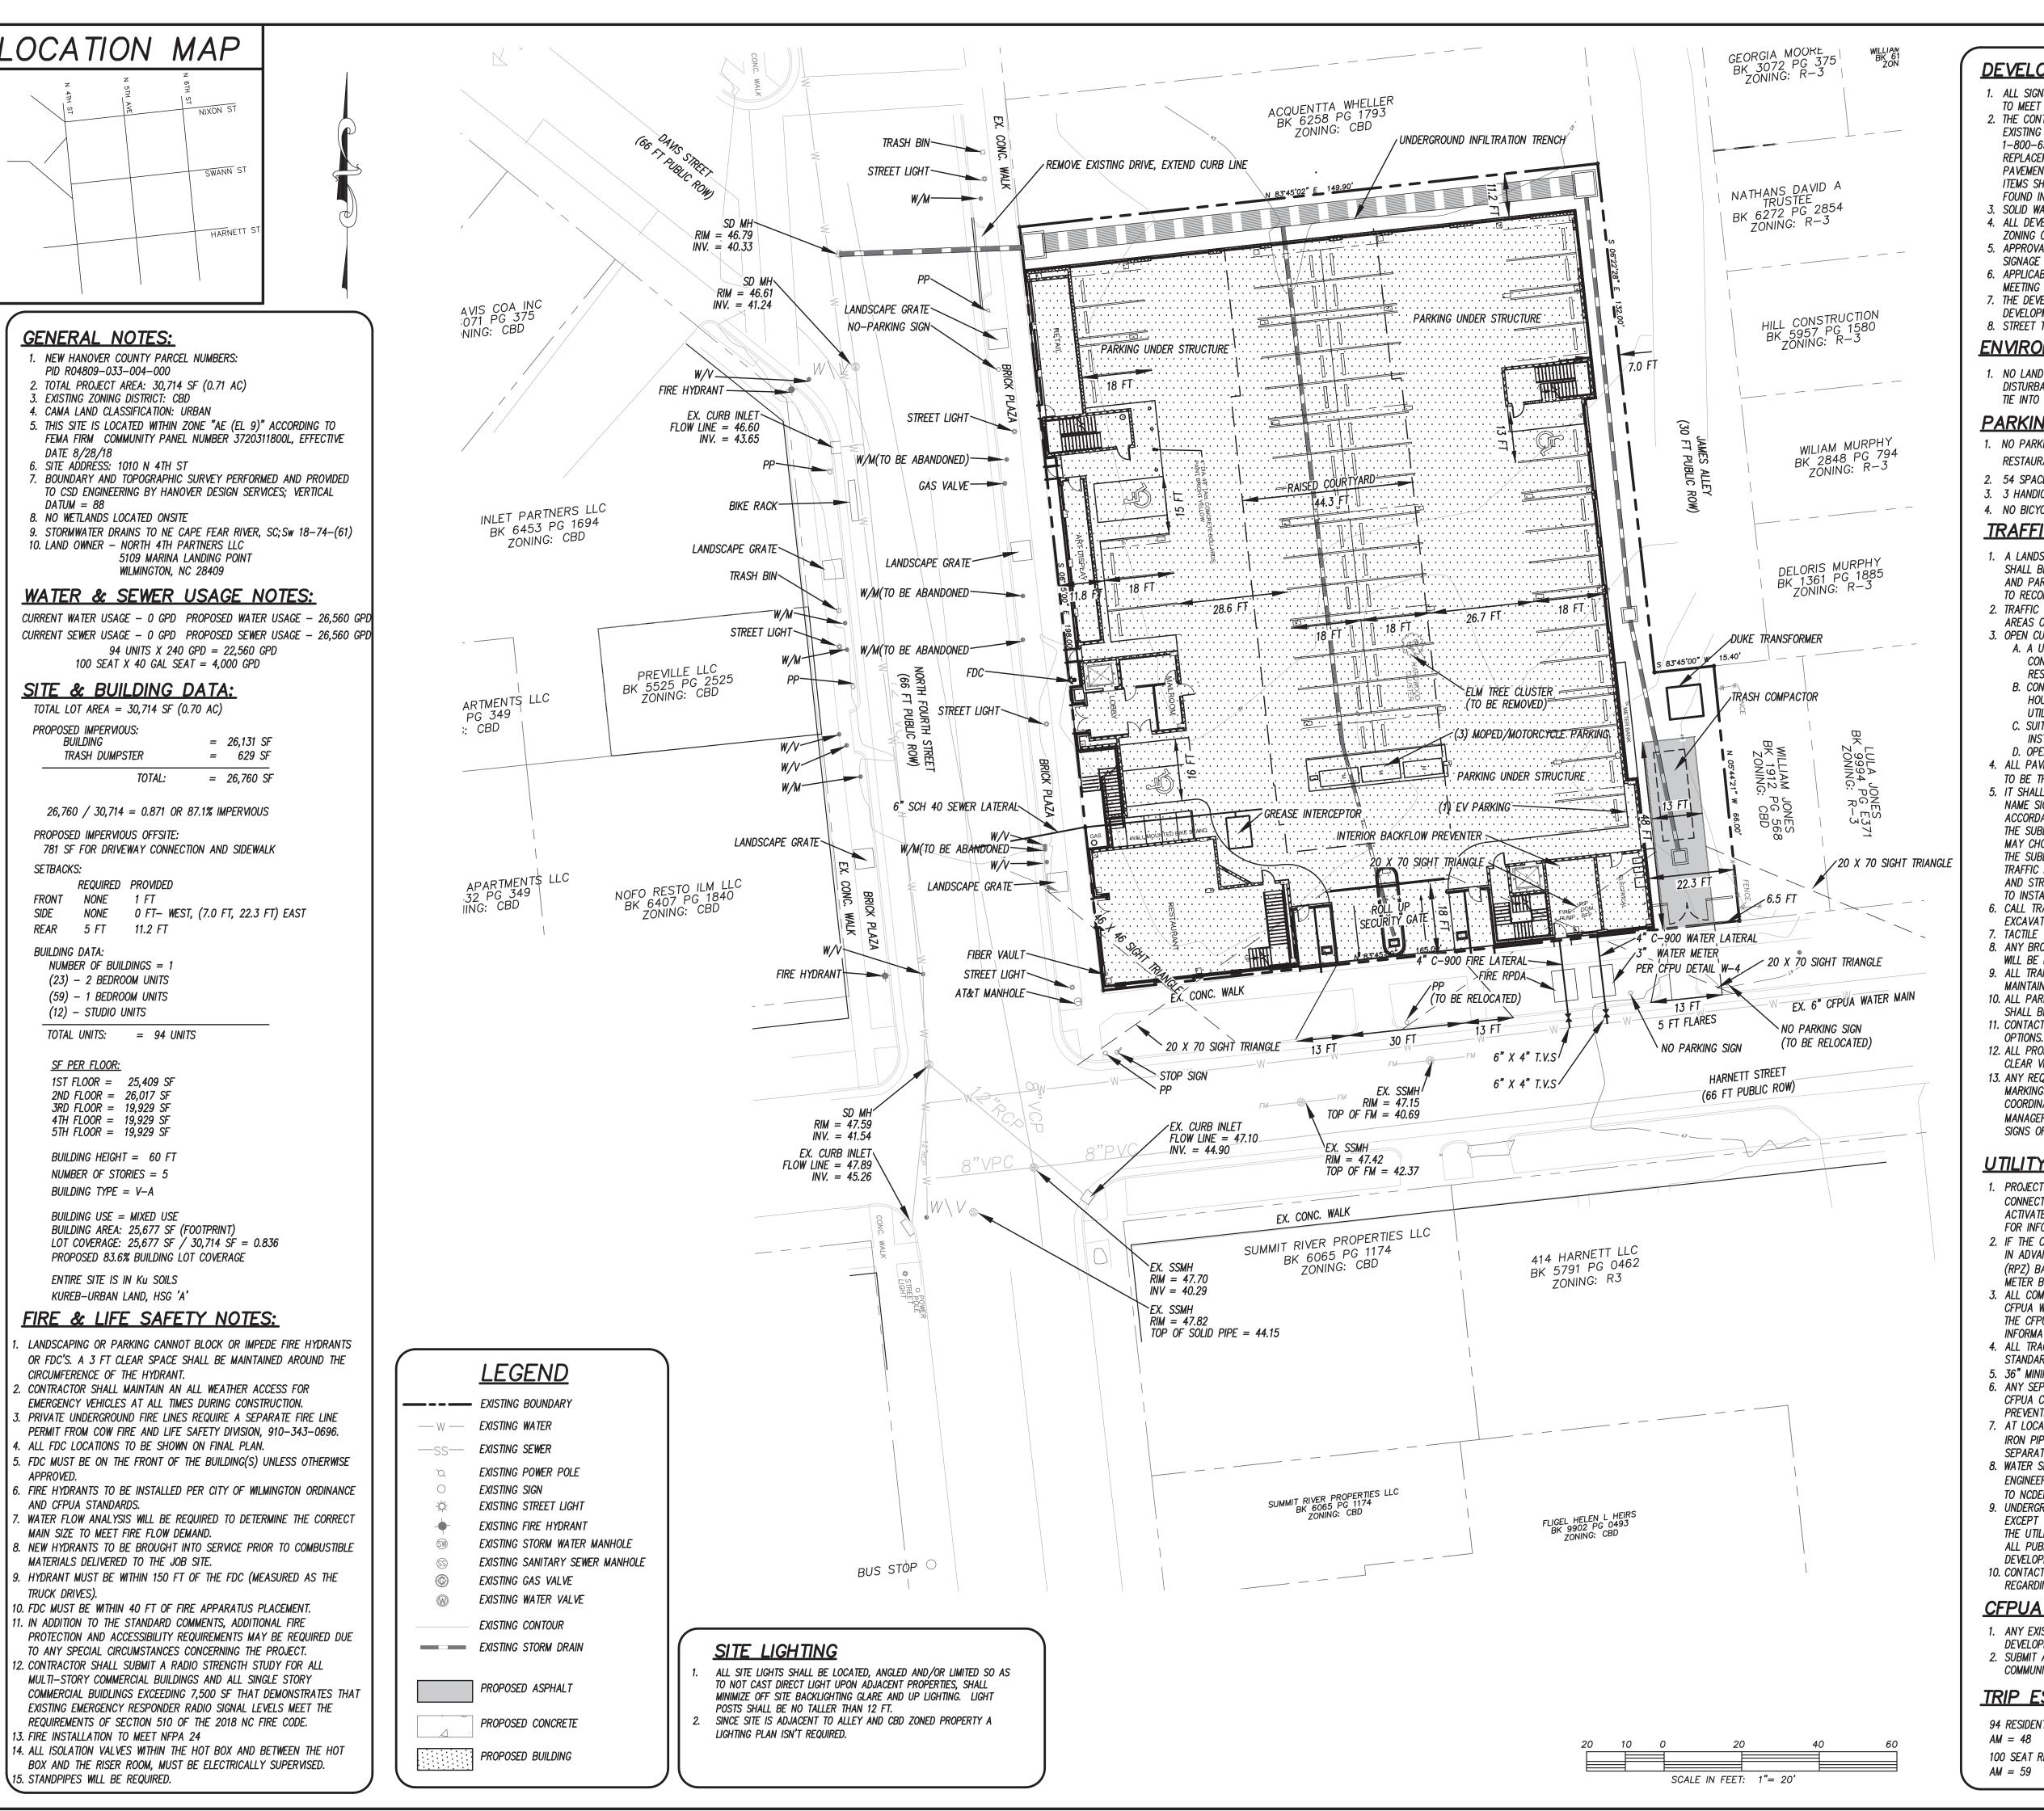

DEVELOPMENT NOTES:

- 1. ALL SIGNS AND PAVEMENT MARKINGS IN AREAS OPEN TO PUBLIC TRAFFIC ARE
- TO MEET MUTCD STANDARDS.

 2. THE CONTRACTOR IS RESPONSIBLE FOR THE LOCATION AND PROTECTION OF EXISTING UTILITIES DURING CONSTRUCTION. CALL U-LOCO AT
- 1-800-632-4949. CONTRACTOR IS RESPONSIBLE FOR THE REPAIR AND REPLACEMENT OF ANY UTILITIES, CURB AND GUTTER, SIDEWALK PANELS, PAVEMENT, ETC. THAT MAY BE DAMAGED DURING CONSTRUCTION. DAMAGED ITEMS SHALL BE REPAIRED TO AT LEAST THE QUALITY OR WORKMANSHIP FOUND IN THE ORIGINAL ITEM.
- S. SOLID WASTE DISPOSAL WILL BE TRASH DUMPSTER SERVICE
- 4. ALL DEVELOPMENT SHALL BE IN ACCORDANCE WITH THE CITY OF WILMINGTON ZONING ORDINANCE & SUBDIVISION REGULATIONS.
- APPROVAL OF SITE PLAN DOES NOT CONSTITUTE APPROVAL OF PROPOSED SIGNAGE FOR THIS SITE. A SEPARATE SIGN PERMIT MUST BE OBTAINED.
 APPLICABLE STREET FRONTAGES SHALL HAVE NATURAL VEGETATIVE SCREENING
- MEETING CITY REQUIREMENTS.
 7. THE DEVELOPMENT SHALL COMPLY WITH ALL CITY TECHNICAL STANDARDS AND
- DEVELOPMENT REGULATIONS.

 8. STREET TREES MUST BE LOCATED A MINIMUM OF 15 FT FROM STREET LIGHTS.

ENVIRONMENTAL NOTES:

1. NO LAND DISTURBANCE IS PERMITTED OUTSIDE THE DESIGNATED LIMITS OF DISTURBANCE FOR SITE IMPROVEMENTS OTHER THAN WHAT IS NECESSARY TO TIE INTO EXISTING CONTOURS OR MEET LANDSCAPING REQUIREMENTS.

PARKING NOTES:

- 1. NO PARKING REQUIRED FOR CBD ZONING
- RESTAURANT PARKING = 1 SPACE PER 2.5 SEATS IN RESTAURANT = 40
- 2. 54 SPACES PROVIDED
 3 3 HANDICAP SPACES PROVIDED
- 3. 3 HANDICAP SPACES PROVIDED
- 4. NO BICYCLE PARKING REQUIRED IN CBD

TRAFFIC ENGINEERING NOTES:

- 1. A LANDSCAPING PLAN INDICATING THE LOCATION OF REQUIRED STREET TREES SHALL BE SUBMITTED TO THE CITY OF WILMINGTON TRAFFIC ENGINEERING DIVISION AND PARKS AND RECREATION DEPARTMENT FOR REVIEW AND APPROVAL PRIOR TO RECORDING OF THE FINAL PLAT. PLAN SHALL ADHERE TO SD 15–14.
- 2. TRAFFIC CONTROL DEVICES (INCLUDING SIGNS AND PAVEMENT MARKINGS) IN AREAS OPEN TO PUBLIC TRAFFIC ARE TO MEET MUTCD STANDARDS.

 3. OPEN CUT NOTES:
- A. A UTILITY CUT PERMIT IS REQUIRED FOR EACH OPEN CUT OF A CITY STREET.

 CONTACT 910-341-5899 FOR MORE DETAILS. IN CERTAIN CASES AN ENTIRE

 RESURFACING OF THE AREA BEING OPEN CUT MAY BE REQUIRED.
- B. CONTRACTOR TO COORDINATE WITH CITY OF WILMINGTON FOR ACCEPTABLE HOURS OF CONSTRUCTION AND TRAFFIC CONTROL DURING INSTALLATION OF UTILITIES IN CITY ROADS.

 C. SUITABLE COMPACTION AND APPROVED STONE & BASE COURSES TO BE
- INSTALLED IN PLACE OF OPEN CUT. D. OPEN CUT TO BE SAW CUT.
- 4. ALL PAVEMENT MARKINGS IN PUBLIC RIGHTS OF WAY AND FOR DRIVEWAYS ARE TO BE THERMOPLASTIC AND MEET CITY AND/OR NCDOT STANDARDS.
- 5. IT SHALL BE THE RESPONSIBILITY OF THE SUBDIVIDER TO ERECT OFFICIAL STREET NAME SIGNS AT ALL INTERSECTIONS ASSOCIATED WITH THE SUBDIVISION IN ACCORDANCE WITH THE TECHNICAL STANDARDS AND SPECIFICATIONS MANUAL. THE SUBDIVIDER MAY ACQUIRE AND ERECT OFFICIAL STREET NAME SIGNS OR MAY CHOOSE TO CONTRACT WITH THE CITY TO INSTALL THE STREET SIGNS AND THE SUBDIVIDER SHALL PAY THE COST OF SUCH INSTALLATION. CONTACT TRAFFIC ENGINEERING AT 341-7888 TO DISCUSS INSTALLATION OF TRAFFIC AND AND STREET NAME SIGNS. PROPOSED STREET NAMES MUST BE APPROVED PRIOR TO INSTALLATION OF STREET NAME SIGNS.
- CALL TRAFFIC ENGINEERING AT 341-7888 FORTY-EIGHT HOURS PRIOR TO ANY EXCAVATION IN THE RIGHT OF WAY.
- 7. TACTILE WARNING MATS ARE TO BE INSTALLED ON ALL WHEELCHAIR RAMPS. 8. ANY BROKEN OR MISSING SIDEWALK PANELS, DRIVEWAY PANELS AND CURBIN
- WILL BE REPLACED.

 9. ALL TRAFFIC CONTROL SIGNS AND MARKINGS OFF THE RIGHT OF WAY ARE TO BE MAINTAINED BY THE PROPERTY OWNER IN ACCORDANCE WITH MUTCD STANDARDS.
- 10. ALL PARKING STALL MARKINGS AND LANE ARROWS WITHIN THE PARKING AREA SHALL BE WHITE.
- 11. CONTACT TRAFFIC ENGINEERING AT 341-7888 TO DISCUSS STREET LIGHTING OPTIONS.
- 12. ALL PROPOSED VEGETATION WITHIN SIGHT TRIANGLES SHALL NOT INTERFERE WITH CLEAR VISUAL SIGHT LINES FROM 30 INCHES 10 FT.
- 13. ANY REQUIRED INSTALLATION OR RELOCATION OF TRAFFIC SIGNS/PAVEMENT MARKINGS IS THE RESPONSIBILITY OF THE PROJECT DEVELOPER. PLEASE COORDINATE WITH CITY TRAFFIC SIGNS AND PAVEMENT MARKINGS MANAGER/SUPERVISOR PRIOR TO INSTALLATION/RELOCATION OF ANY TRAFFIC SIGNS OR MARKINGS IN EXISTING OR PROPOSED PUBLIC ROW.

UTILITY NOTES:

- 1. PROJECT SHALL COMPLY WITH THE CITY OF WILMINGTON AND CFPUA CROSS CONNECTION CONTROL REQUIREMENTS. WATER METER(S) CANNOT BE SET AND ACTIVATED ON NEW MAINS UNTIL ALL REQUIREMENTS ARE MET. CALL 343—3910 FOR INFORMATION.
- 2. IF THE CONTRACTOR DESIRES WATER FOR CONSTRUCTION HE/SHE SHALL APPLY IN ADVANCE FOR THIS SERVICE AND MUST PROVIDE A REDUCED PRESSURE ZONE (RPZ) BACKFLOW PREVENTION DEVICE ON THE DEVELOPER'S SIDE OF THE WATER METER BOX
- 3. ALL COMMERCIAL WATER SERVICES AND ANY IRRIGATION SYSTEMS SUPPLIED BY CFPUA WATER SHALL HAVE A BACKFLOW PREVENTION DEVICE ACCEPTABLE TO THE CFPUA AND APPROVED BY USCFCCCHR OR ASSE. CALL 799-6064 FOR INFORMATION.
- 4. ALL TRACER WIRE FOR UTILITY IMPROVEMENTS TO BE INSTALLED PER CFPUA STANDARD SPECIFICATION SECTION 33-01-12.
 5. 36" MINIMUM COVER OVER ALL WATER MAINS.
- 6. ANY SEPARATE CONNECTION FOR IRRIGATION SHALL COMPLY WITH CITY AND CFPUA CROSS—CONNECTION REQUIREMENTS WITH APPROVED BACKFLOW PREVENTION DEVICES.
- 7. AT LOCATIONS WHERE WATER MAIN CROSSES UNDER SANITARY SEWER, DUCTILE IRON PIPE SHALL BE USED ALONG WITH PROVIDING 24" MINIMUM OF VERTICAL SEPARATION.

 8. WATER SERVICES CAN NOT BE ACTIVATED ON NEW WATER MAINS UNTIL
- 8. WATER SERVICES CAN NOT BE ACTIVATED ON NEW WATER MAINS UNTIL ENGINEER'S CERTIFICATION AND APPLICANT'S CERTIFICATION HAVE BEEN PROVIDED TO NCDENR AND "FINAL APPROVAL" ISSUED.

 9. UNDERGROUND UTILITIES— ALL NEW UTILITIES SHALL BE INSTALLED UNDERGROUND.
- EXCEPT WHERE SUCH PLACEMENT IS PROHIBITED OR DEEMED IMPRACTICAL BY THE UTILITY PROVIDER. UNDERGROUND FACILITIES FOR STREET LIGHTING ALONG ALL PUBLIC STREETS ABUTTING THE SUBJECT SITE SHALL BE INSTALLED BY THE DEVELOPER.
- 10. CONTACT 811 PRIOR TO CONTACTING CITY OF WILMINGTON, TRAFFIC ENGINEERING REGARDING THE UTILITIES IN THE ROW.

CFPUA NOTES:

- 1. ANY EXISTING WATER AND SEWER SERVICES NOT BEING USED BY THIS DEVELOPMENT MUST BE ABANDONED PER CFPUA SPECIFICATIONS.
- 2. SUBMIT ALL GREASE INTERCEPTOR AND BACKFLOW INFORMATION TO CFPUA COMMUNITY COMPLIANCE FOR REVIEW AND APPROVAL.

TRIP ESTIMATION

(S)
(SD)
ENGINEERING

LICENSE # C-2710
ENGINEERING
LAND PLANNING
COMMERCIAL / RESIDENTIAL

P.O. BOX 4041 WILMINGTON, NC 28406

(910) 791–4441 (1910) nipidi superpositi s

CSD ENGINEERING, with all rights reserved. The use of this document of by the Engineer is strictly prohibited. Reproductions, additions, and d by the Engineer. Copies of this document must come from the orig

IE HELM

CCATED IN CITY OF WILMINGTON

EW HANOVER COUNTY, NORTH CAROLINA

INER: 1010 NORTH FOURTH STREET, LLC

82 HANOVER STREET

PORTLAND, ME 04101–1979

PRELIMINARY

NOT RELEASED

FOR CONSTRUCTION

REVISED PER TRC COMMENTS

ADDED NOTE 2 IN "SITE LIGHTING"

REVISED PER CFDUA COMMENTS

REVISED INFLITRATION TRENCH, TREE SPECIES

REVISED PER BUILDING CHANGES AND TRC COMMENTS

REVISED PER BUILDING CHANGES AND TRC CHANGES


DATE: 7-21-22


HORZ. SCALE: 1" = 20'
VERT. SCALE: N/A

DRAWN BY: RLW

CHECKED BY: HSR
PROJECT NO.: 22-0595

Sheet No. 3 Of 9

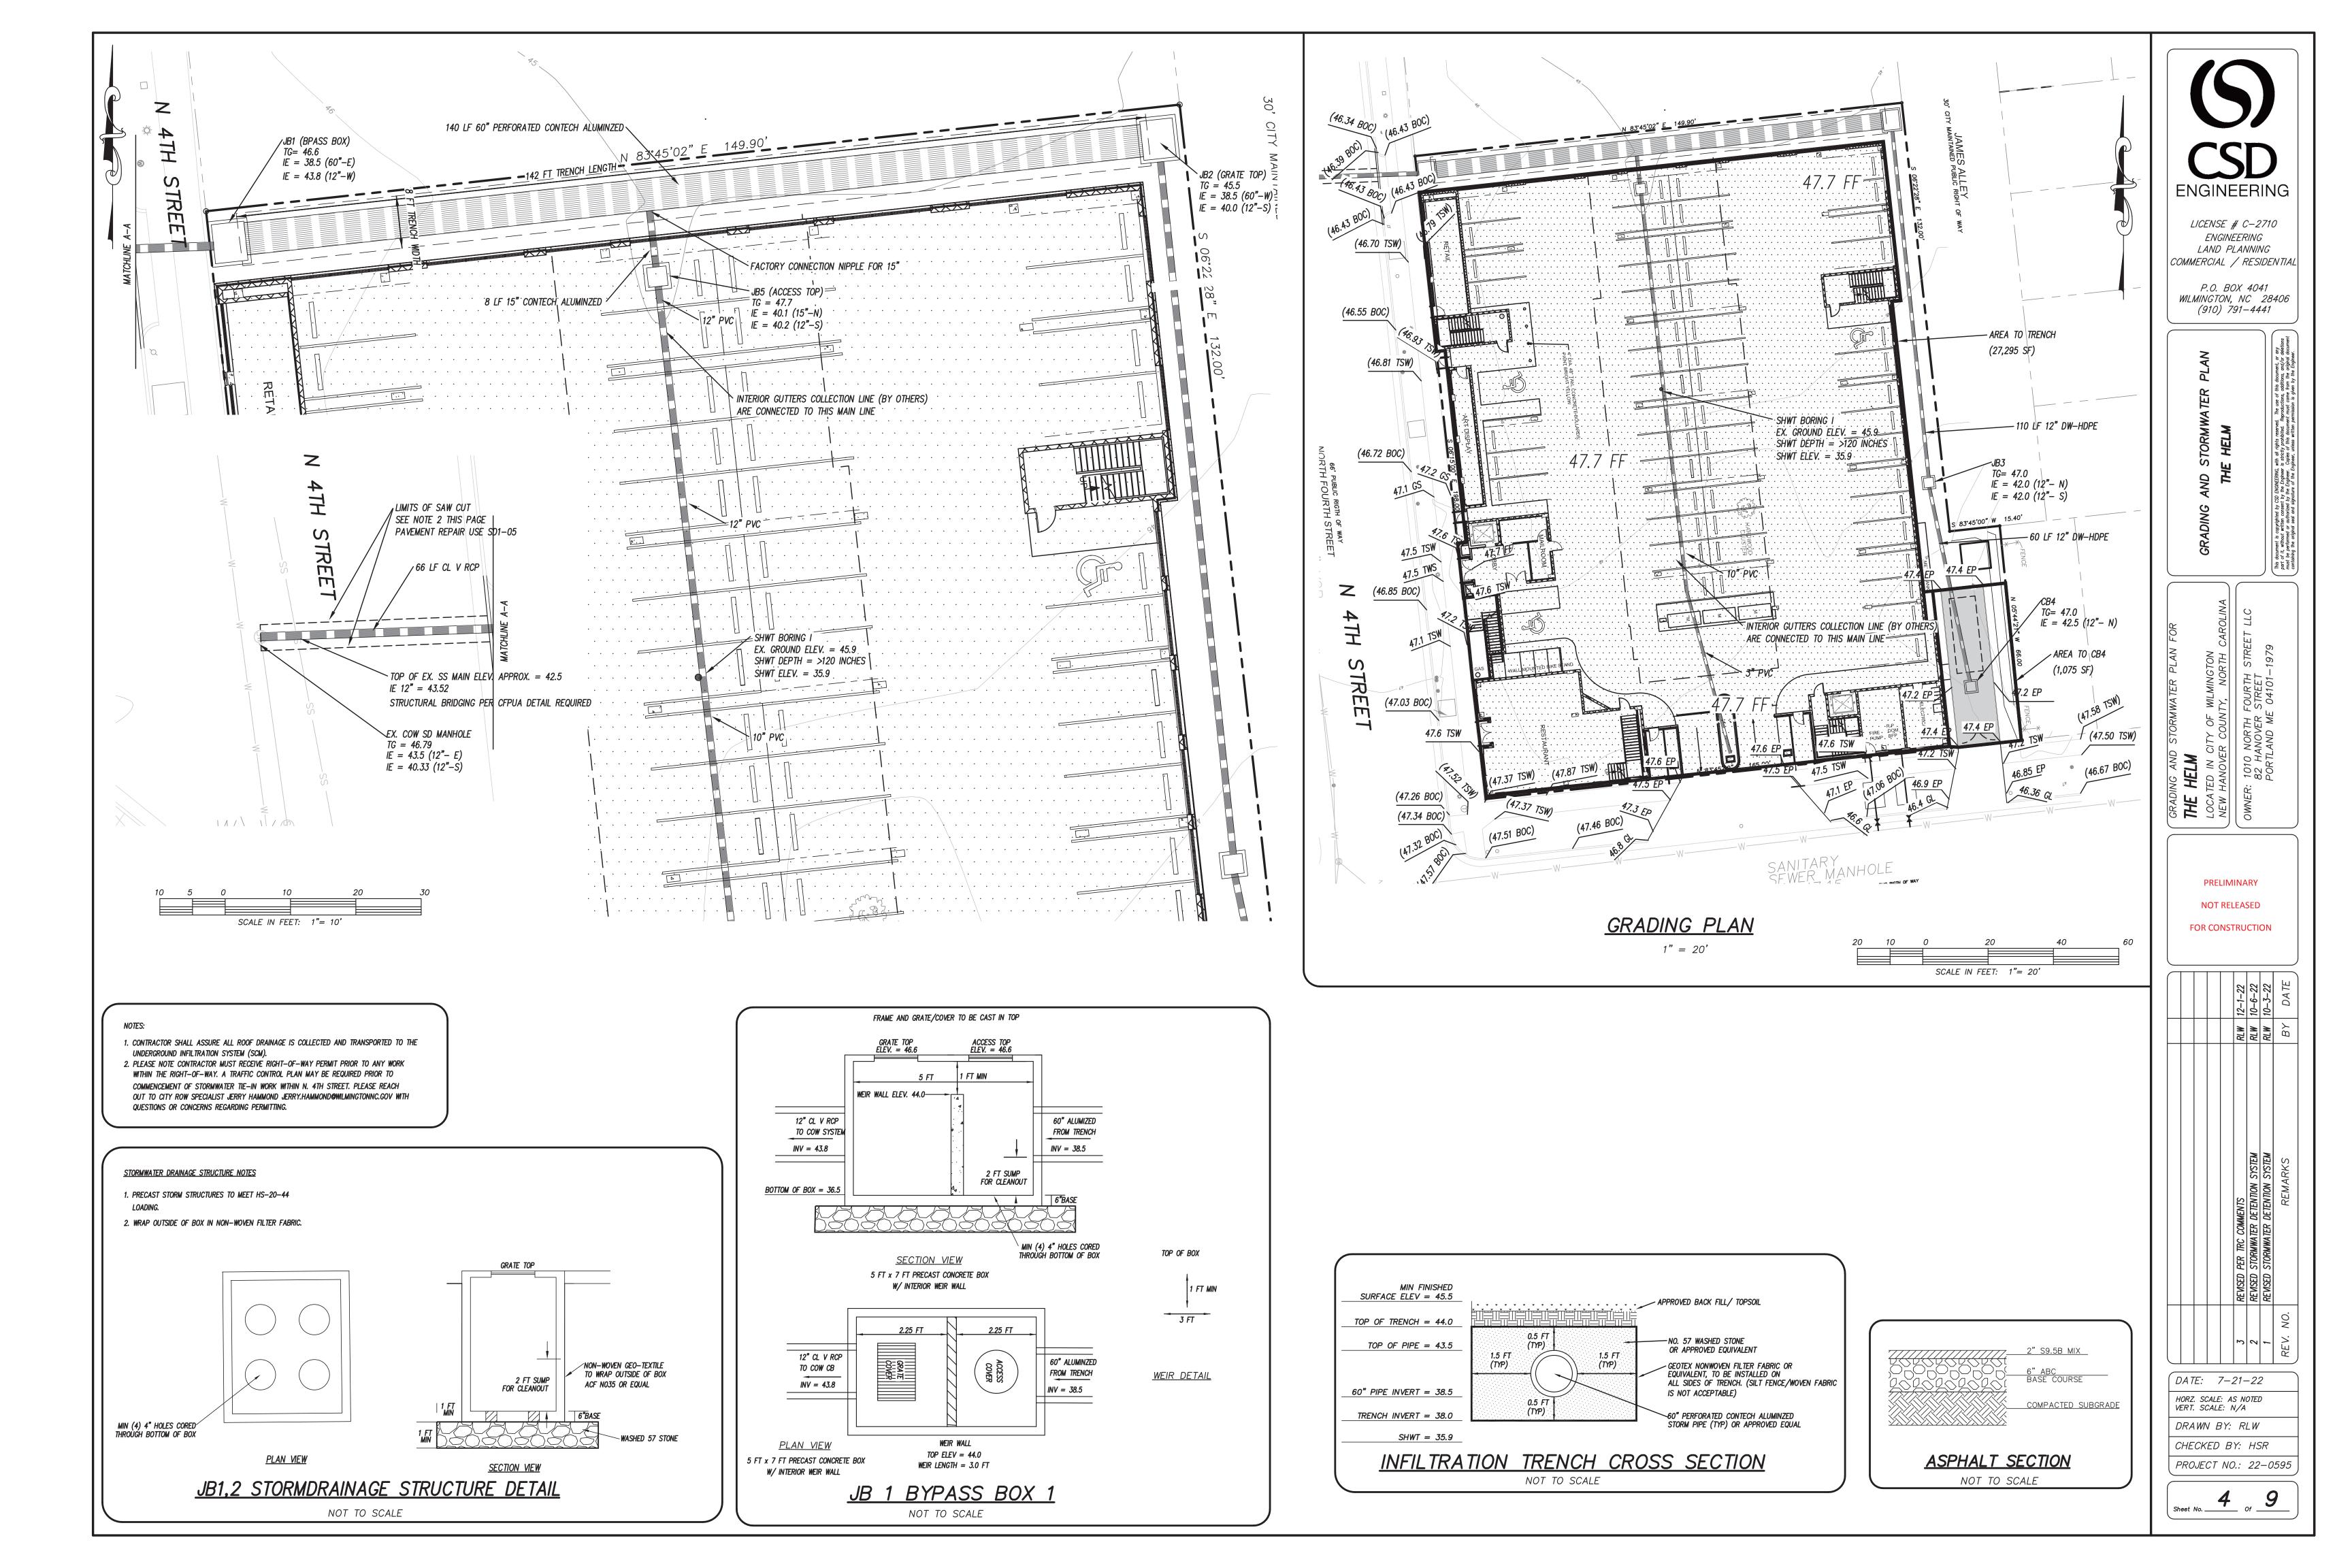

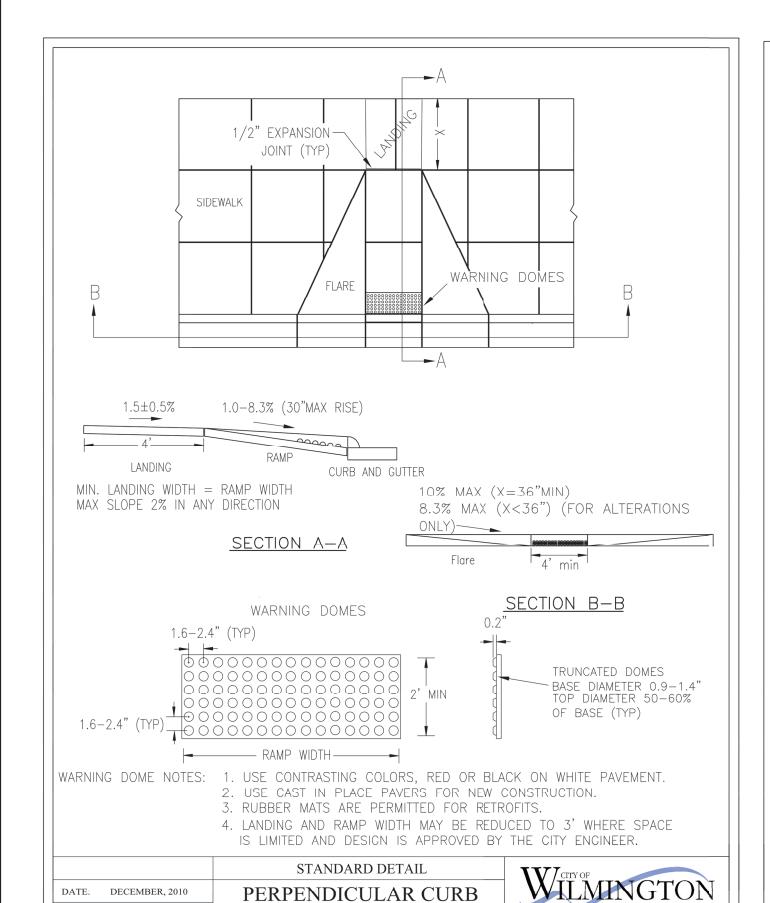

ADJACENT TO WALKING

SURFACE

CITY OF WILMINGTON ENGINEERING


SD 3-07


PO BOX 1810 WILMINGTON N.C. 28402


DRAWN:


CHECKED:


SCALE ____NOT TO SCALE

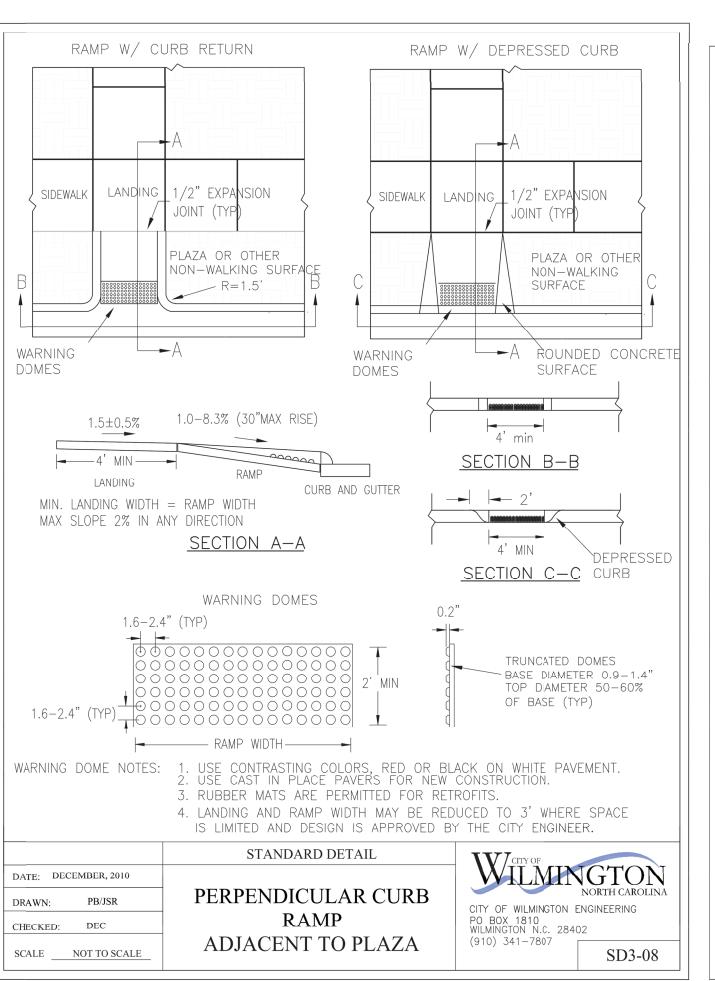


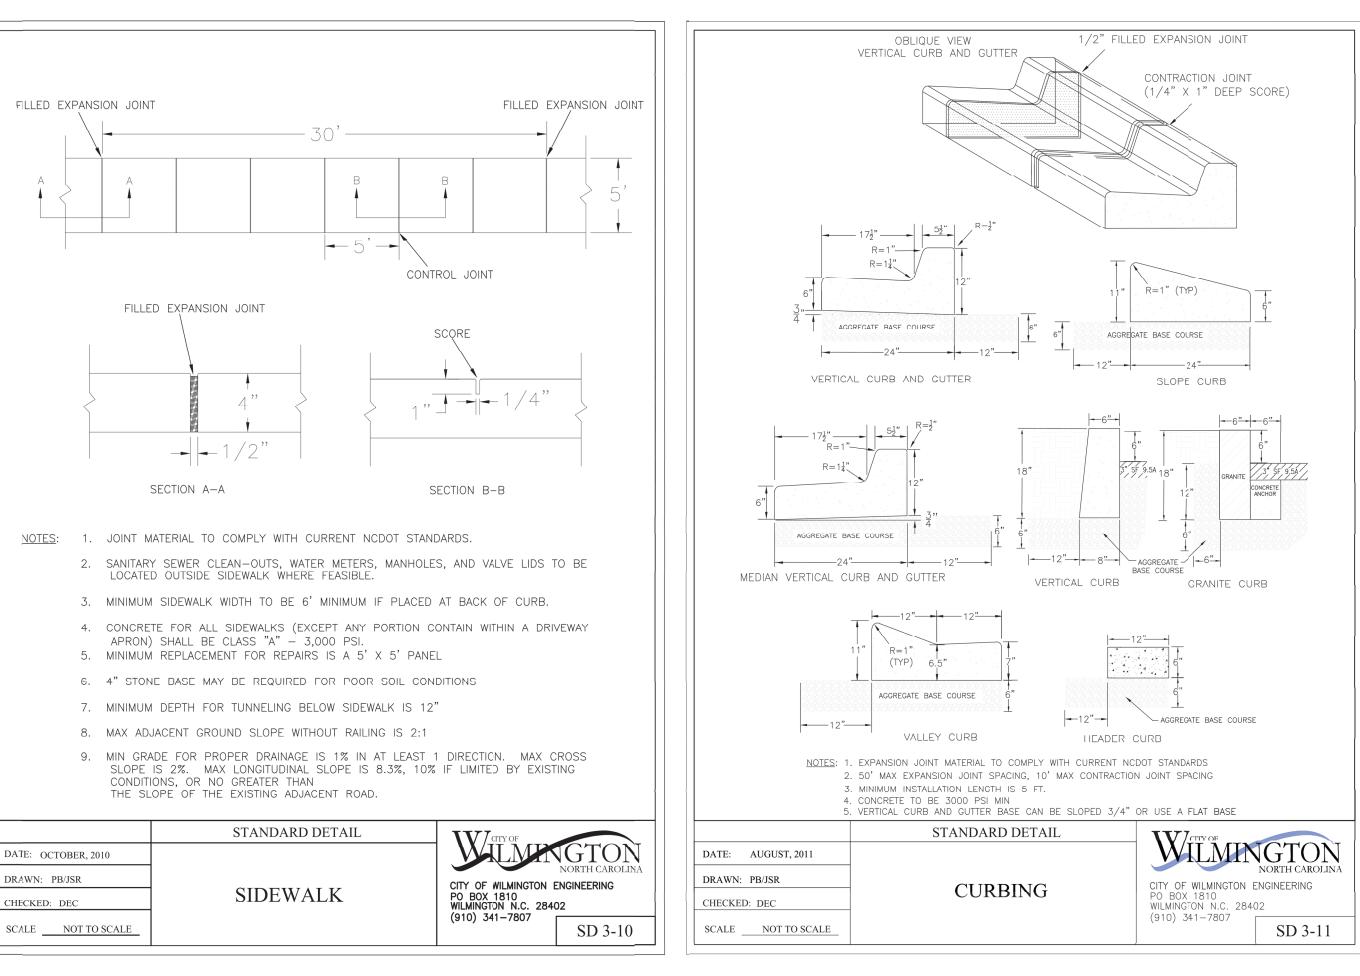

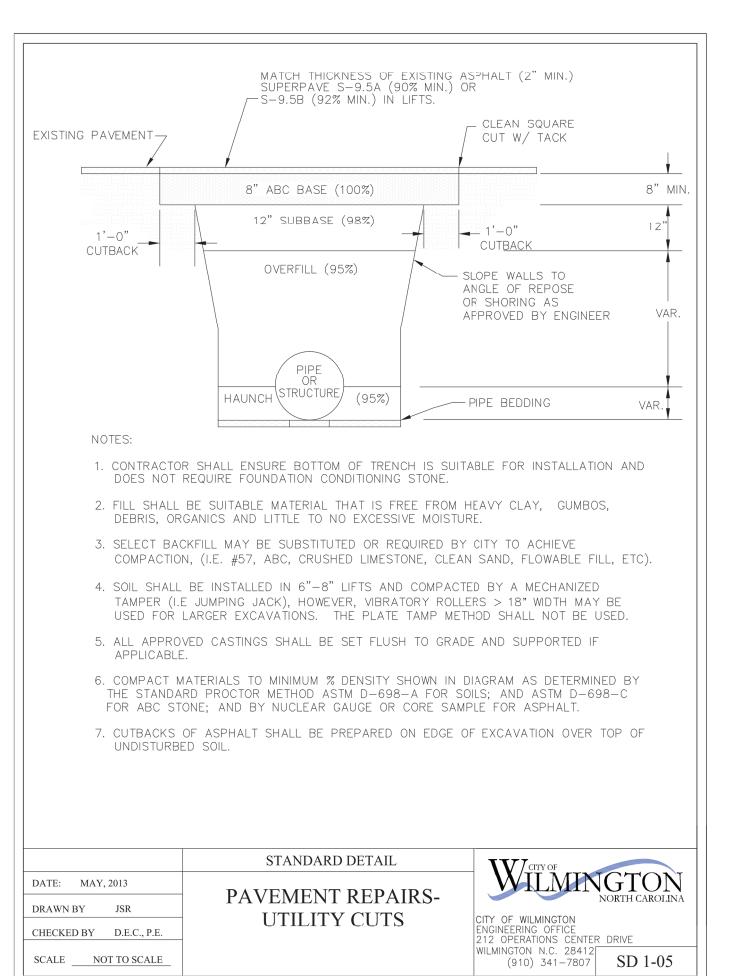

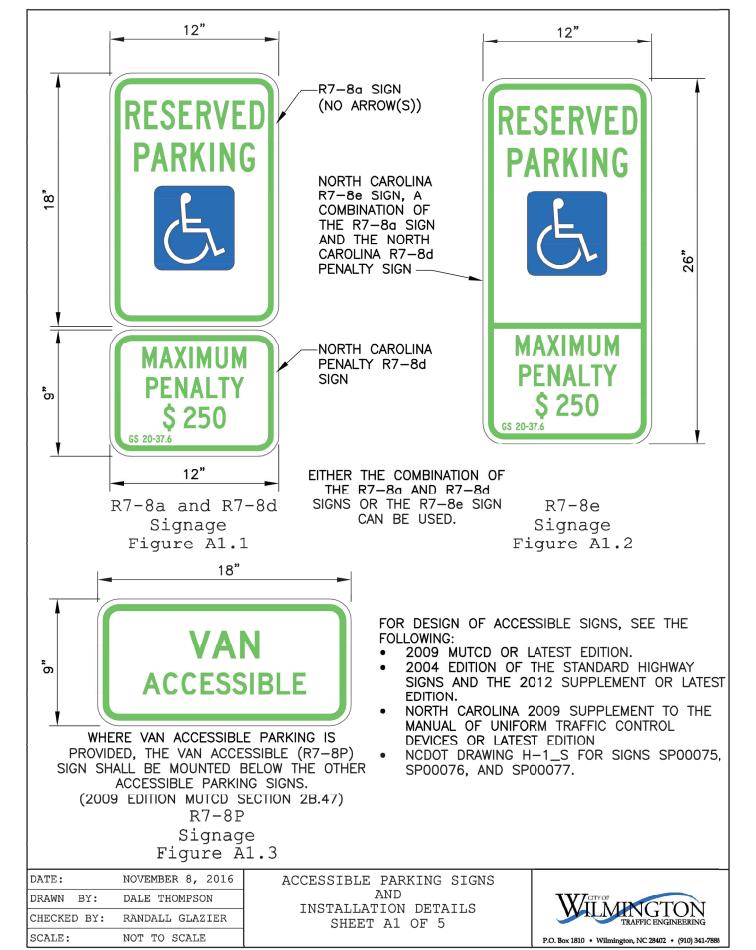


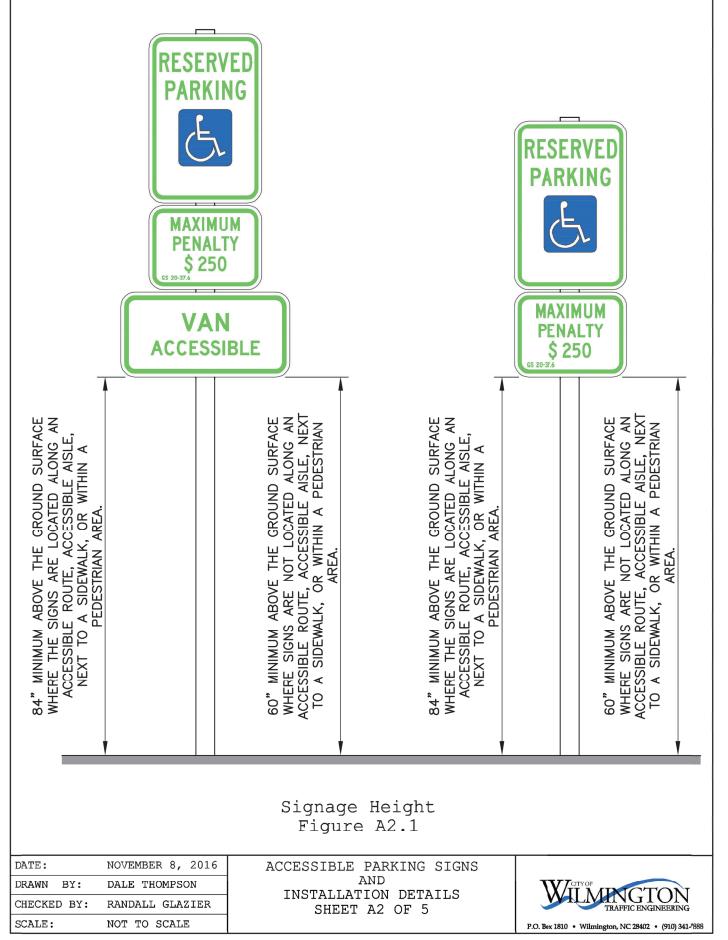

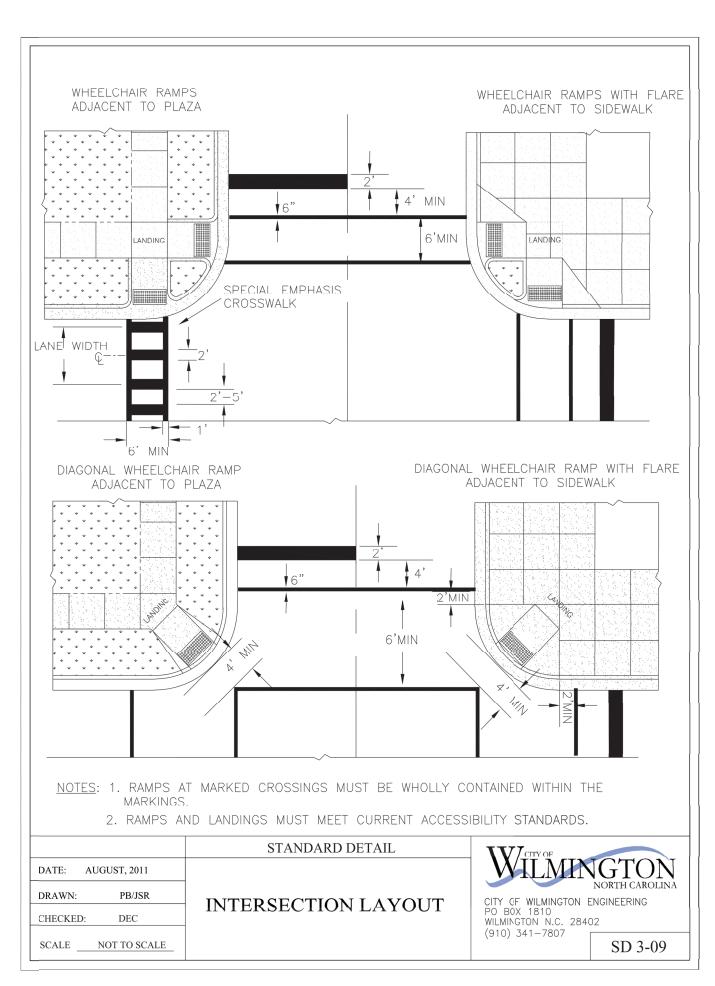






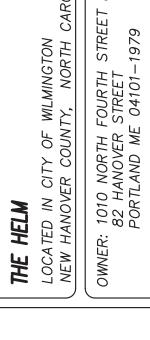



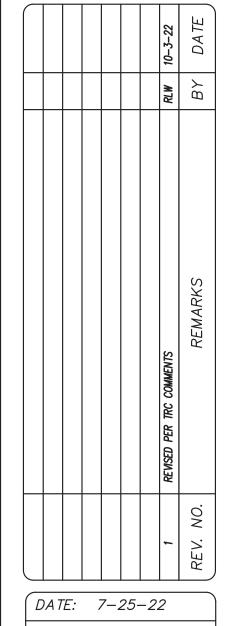

DATE: 7-25-22


HORZ. SCALE: N/A
VERT. SCALE: N/A


DRAWN BY: RLW


CHECKED BY: HSR


PROJECT NO.: 22-0595


Sheet No. _____ Of _____

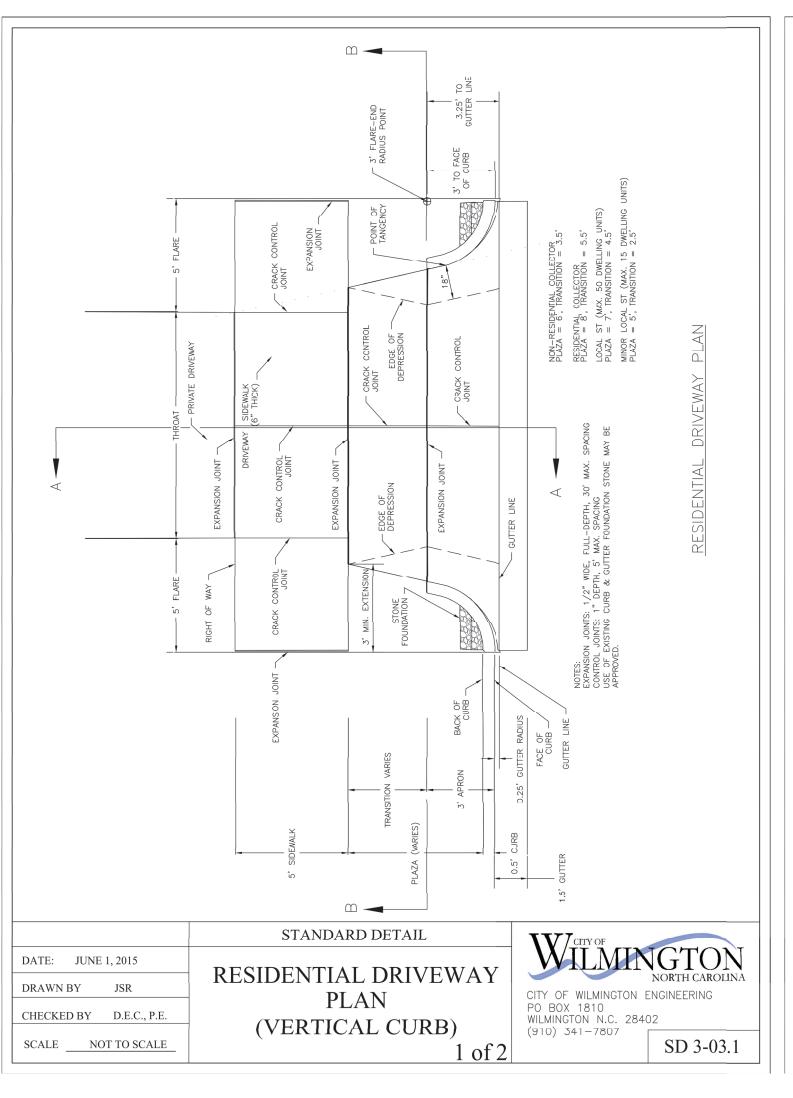

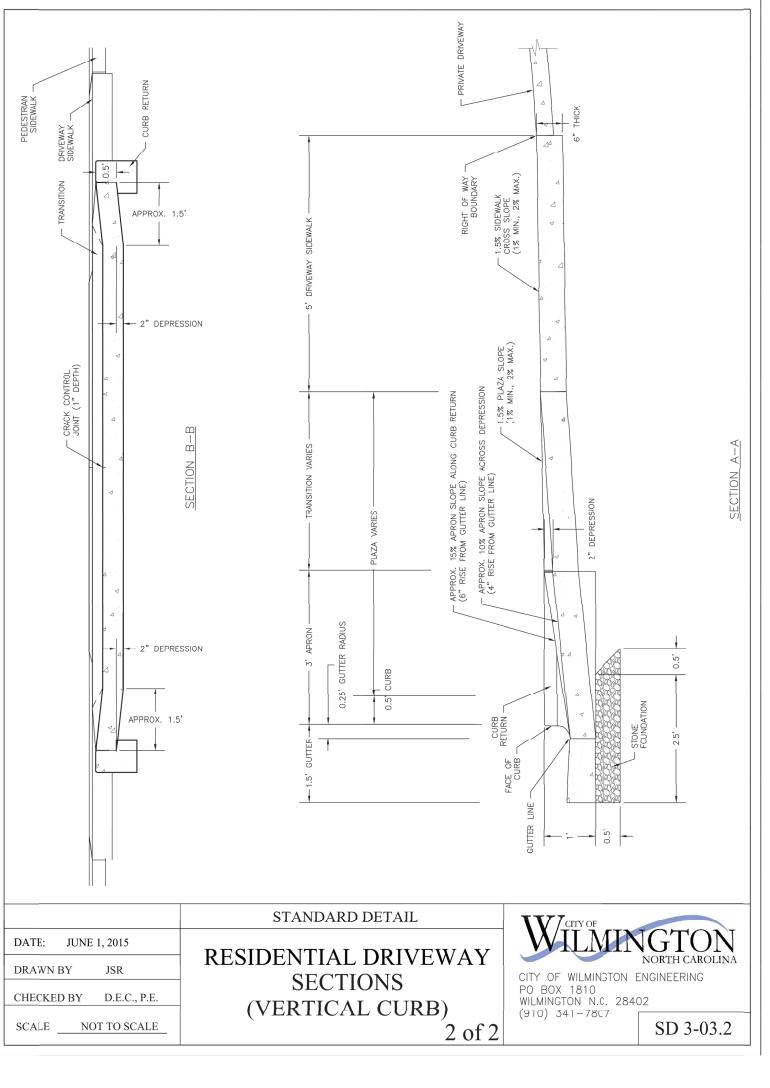

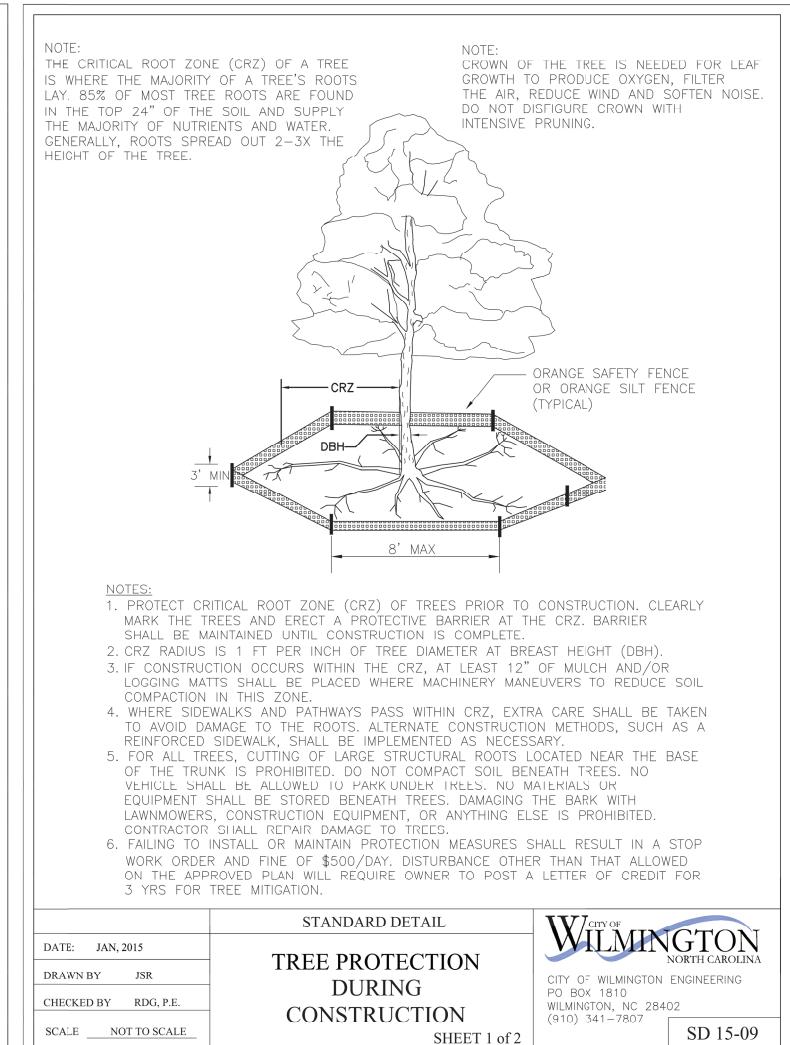


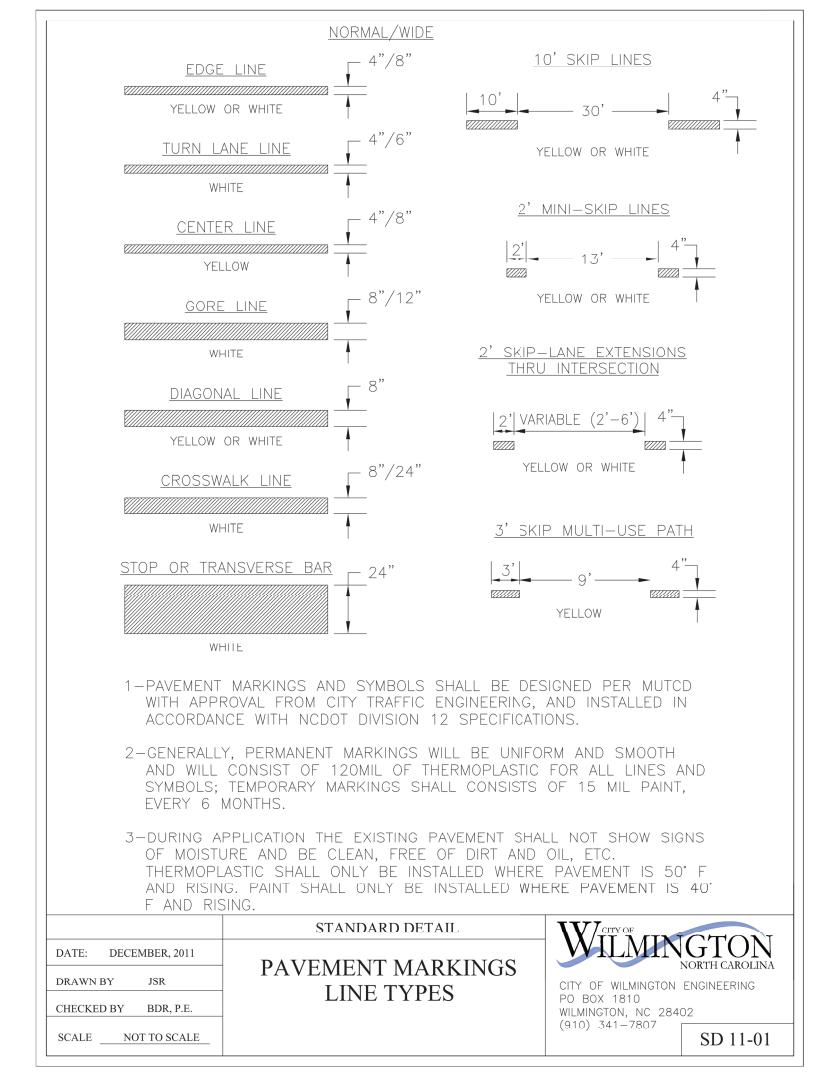


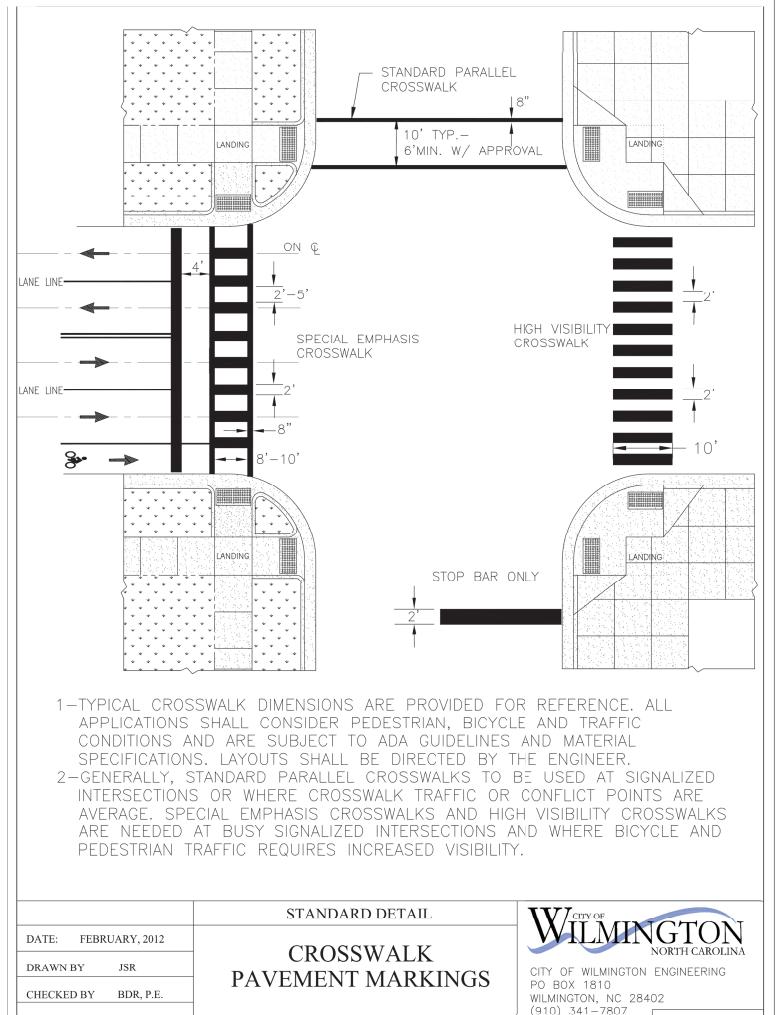


SCALE NOT TO SCALE

SD 11-11

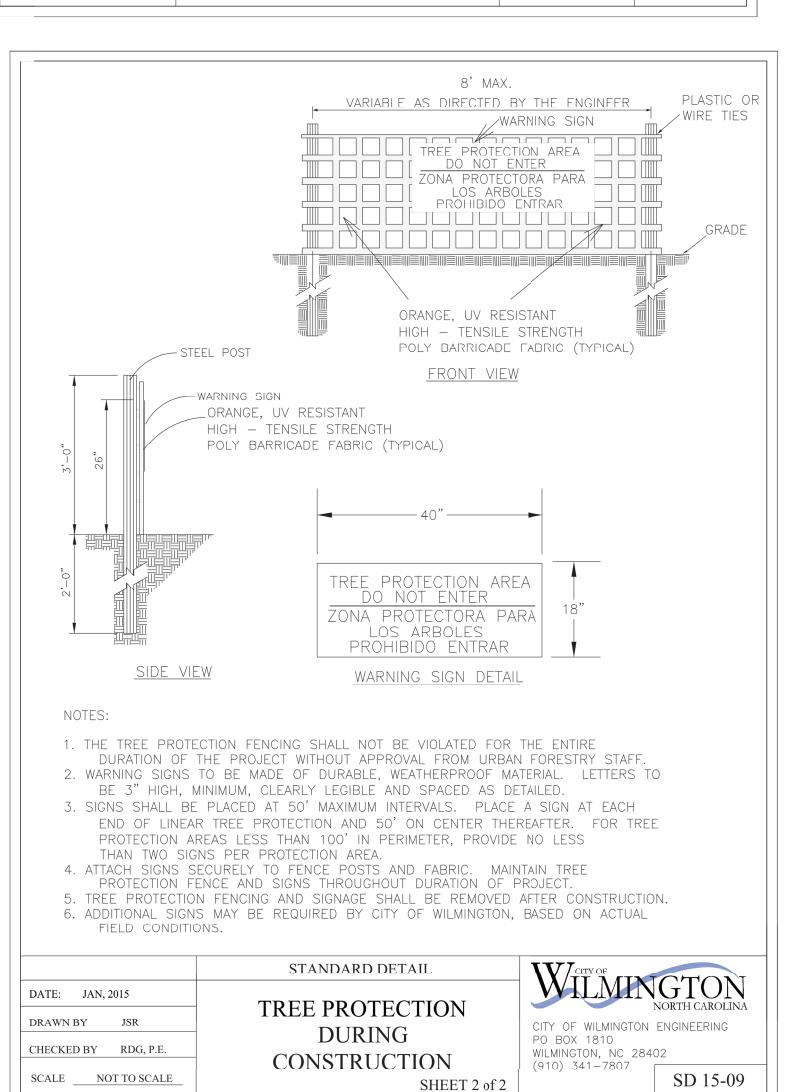

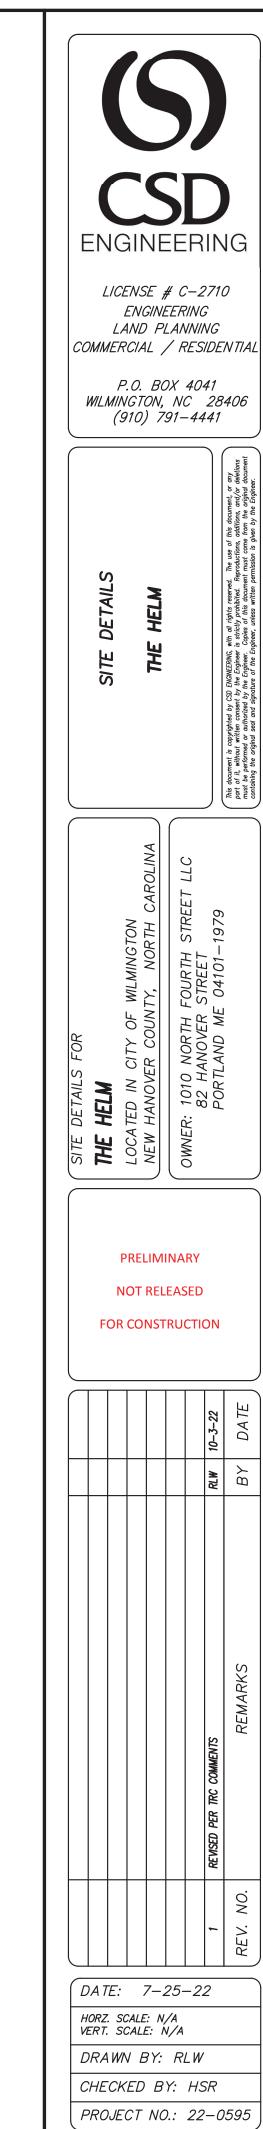

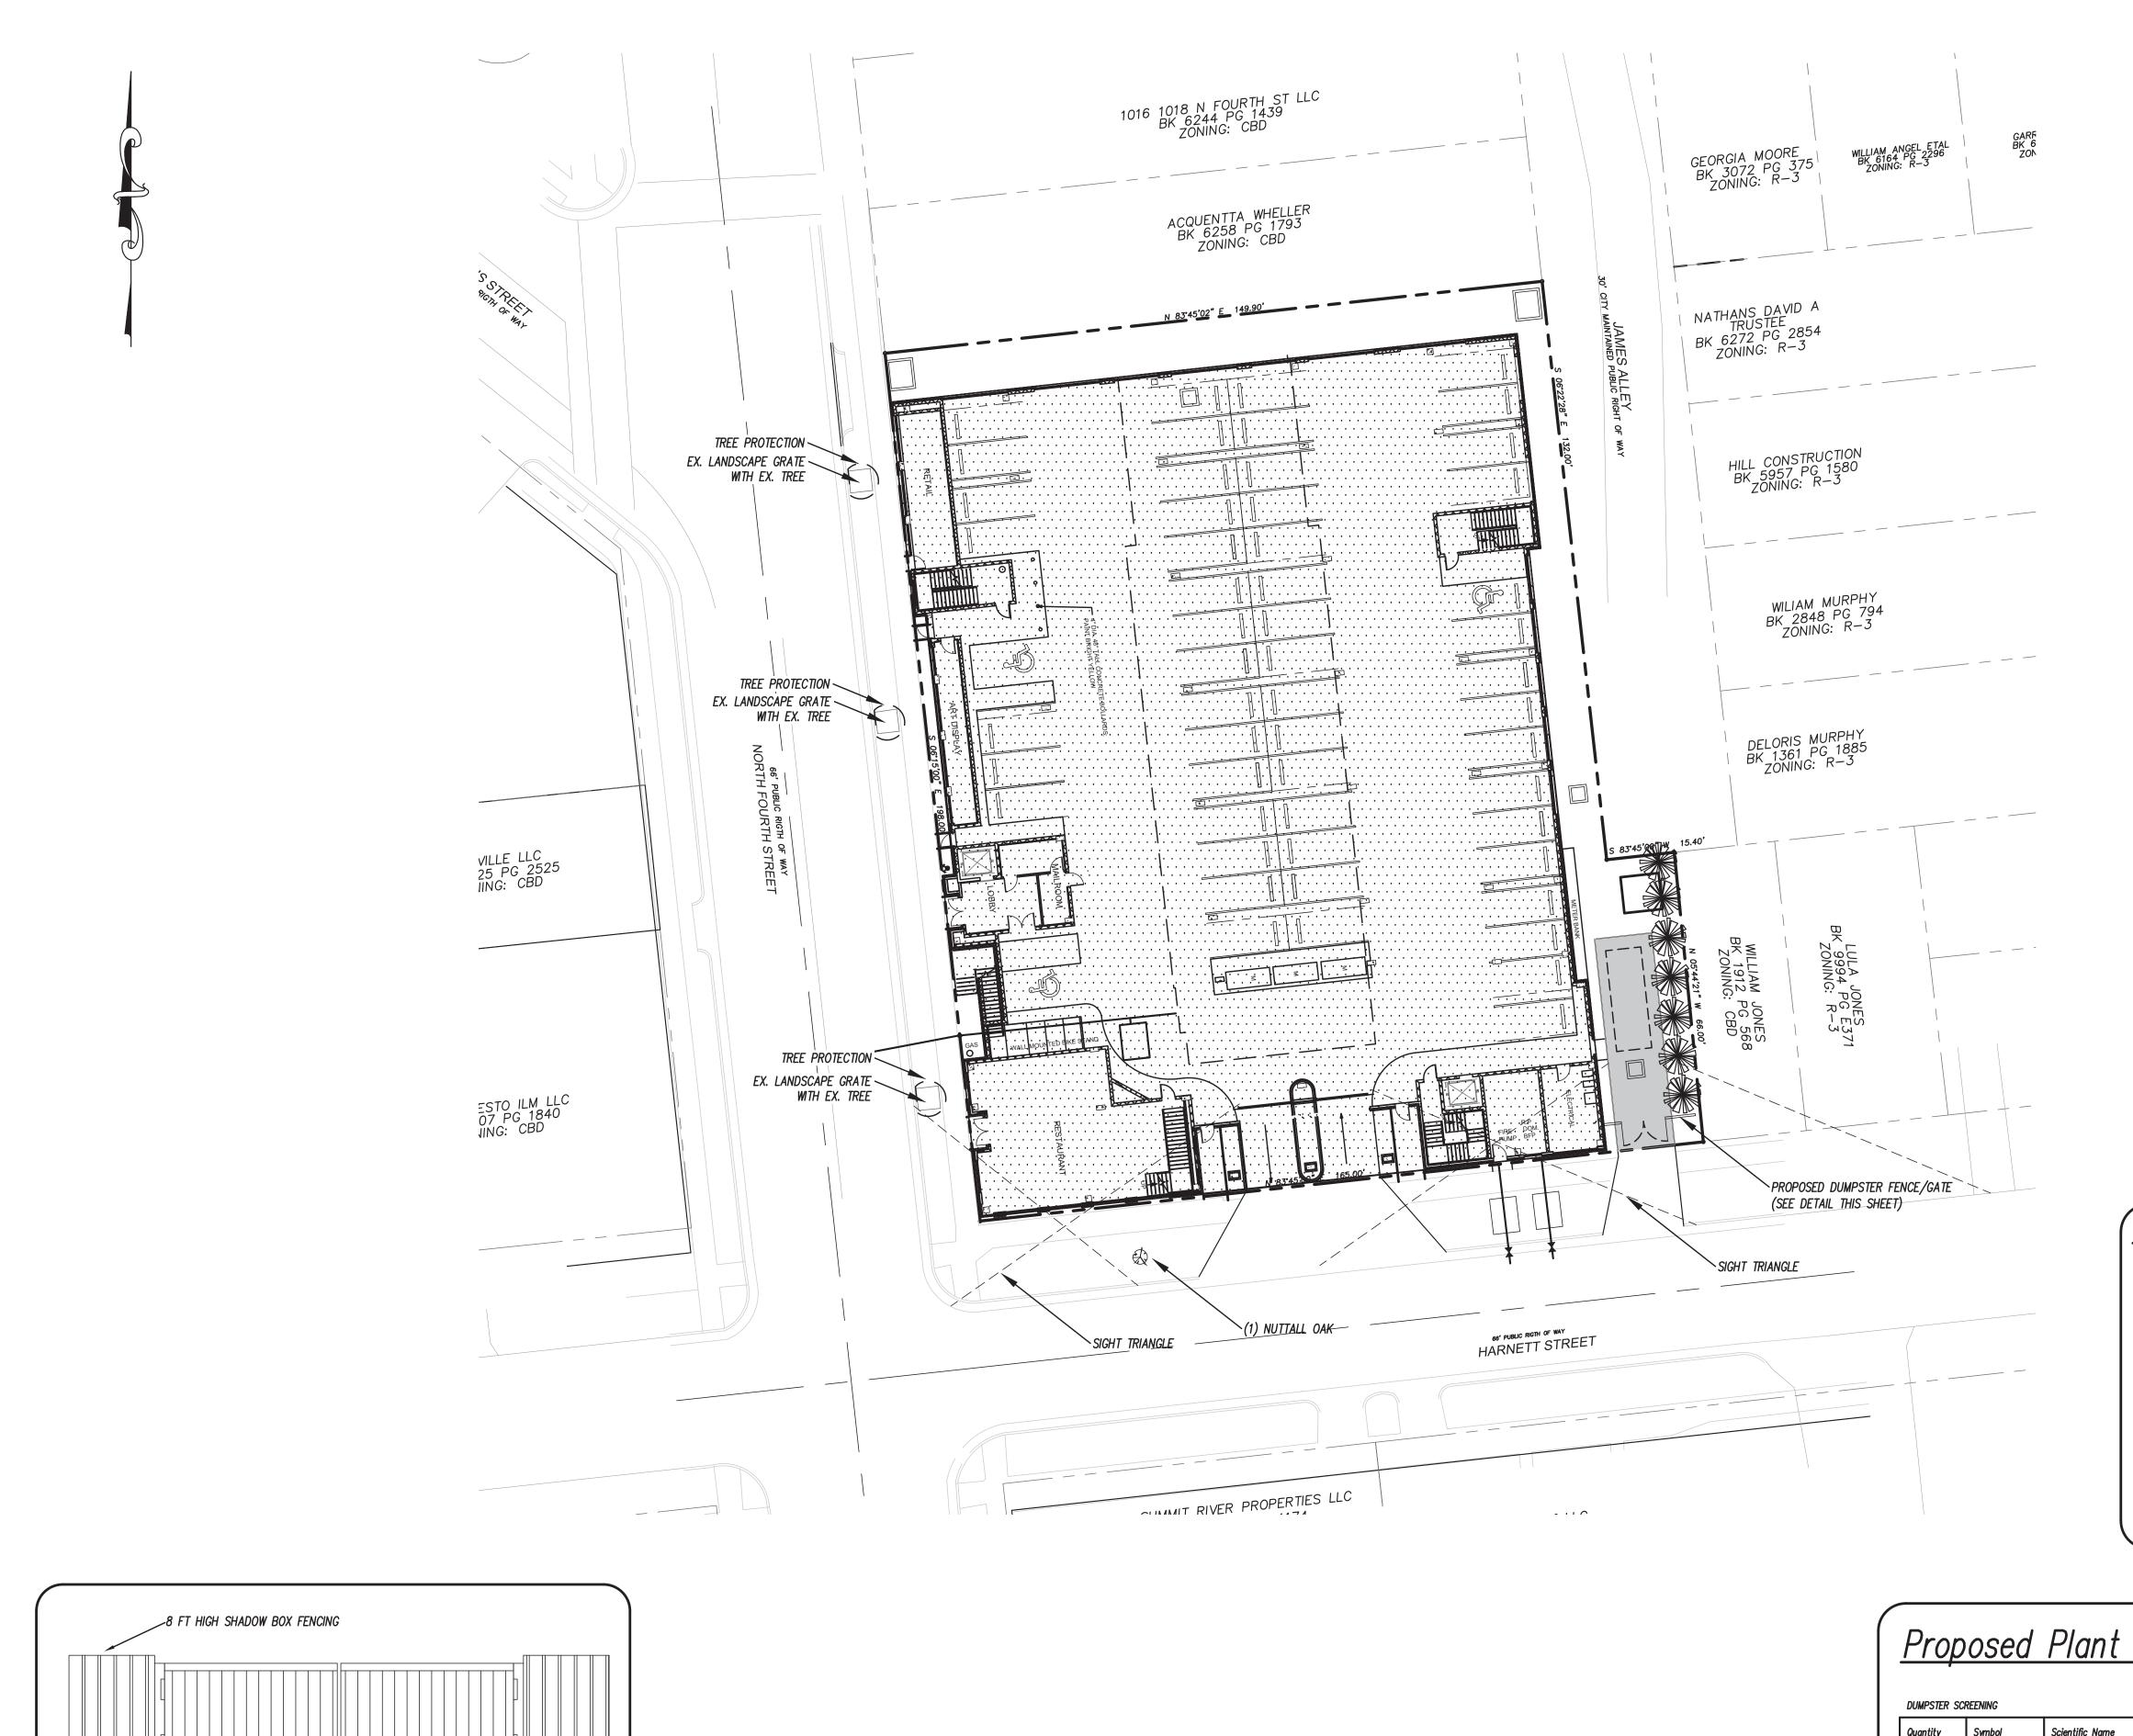

SOLID METAL GATE

DUMPSTER ENCLOSURE

N.T.S.

ENGINEERING

LICENSE # C-2710 ENGINEERING LAND PLANNING COMMERCIAL / RESIDENTIAL

P.O. BOX 4041 WILMINGTON, NC 28406 (910) 791–4441

PRELIMINARY

NOT RELEASED FOR CONSTRUCTION

DATE: 7-25-22 HORZ. SCALE: 1" = 20' VERT. SCALE: N/A

DRAWN BY: RLW CHECKED BY: HSR PROJECT NO.: 22-0595

LANDSCAPE CALCULATIONS: 1. STREET TREES

EXISTING TREES ON NORTH 4TH STREET TO REMAIN HARNETT STREET 165 - (30 + 13) = 122; 122 / 30 = 4


1 STREET TREE PROPOSED DUE TO CONFLICTS WITH UTILITIES AND SIGHT TRIANGLES, 3 TREES WILL BE PAYMENT IN LIEU.

Proposed Plant Table:

All	Quantity	Symbol	Scientific Name	Common Name	Container	Minimum Planting Size	Planting Remarks
7 Myrica cerifera Wax Myrtle 7 Gal. 3 FT DUMPSTER S	7		Myrica cerifera	Wax Myrtle	7 Gal.	3 FT	DUMPSTER SCREEN

STREET TREES						
Quantity	Symbol	Scientific Name	Common Name	Container	Minimum Planting Size	Planting Remarks
1		Quercus nuttalli	Nuttal Oak	B & B	2–2.5" Caliper	Street Trees

O.C. - "ON CENTER" CAL. - "CALIPER AT 6" ABOVE GRADE" GAL. - "GALLON CONTAINER"

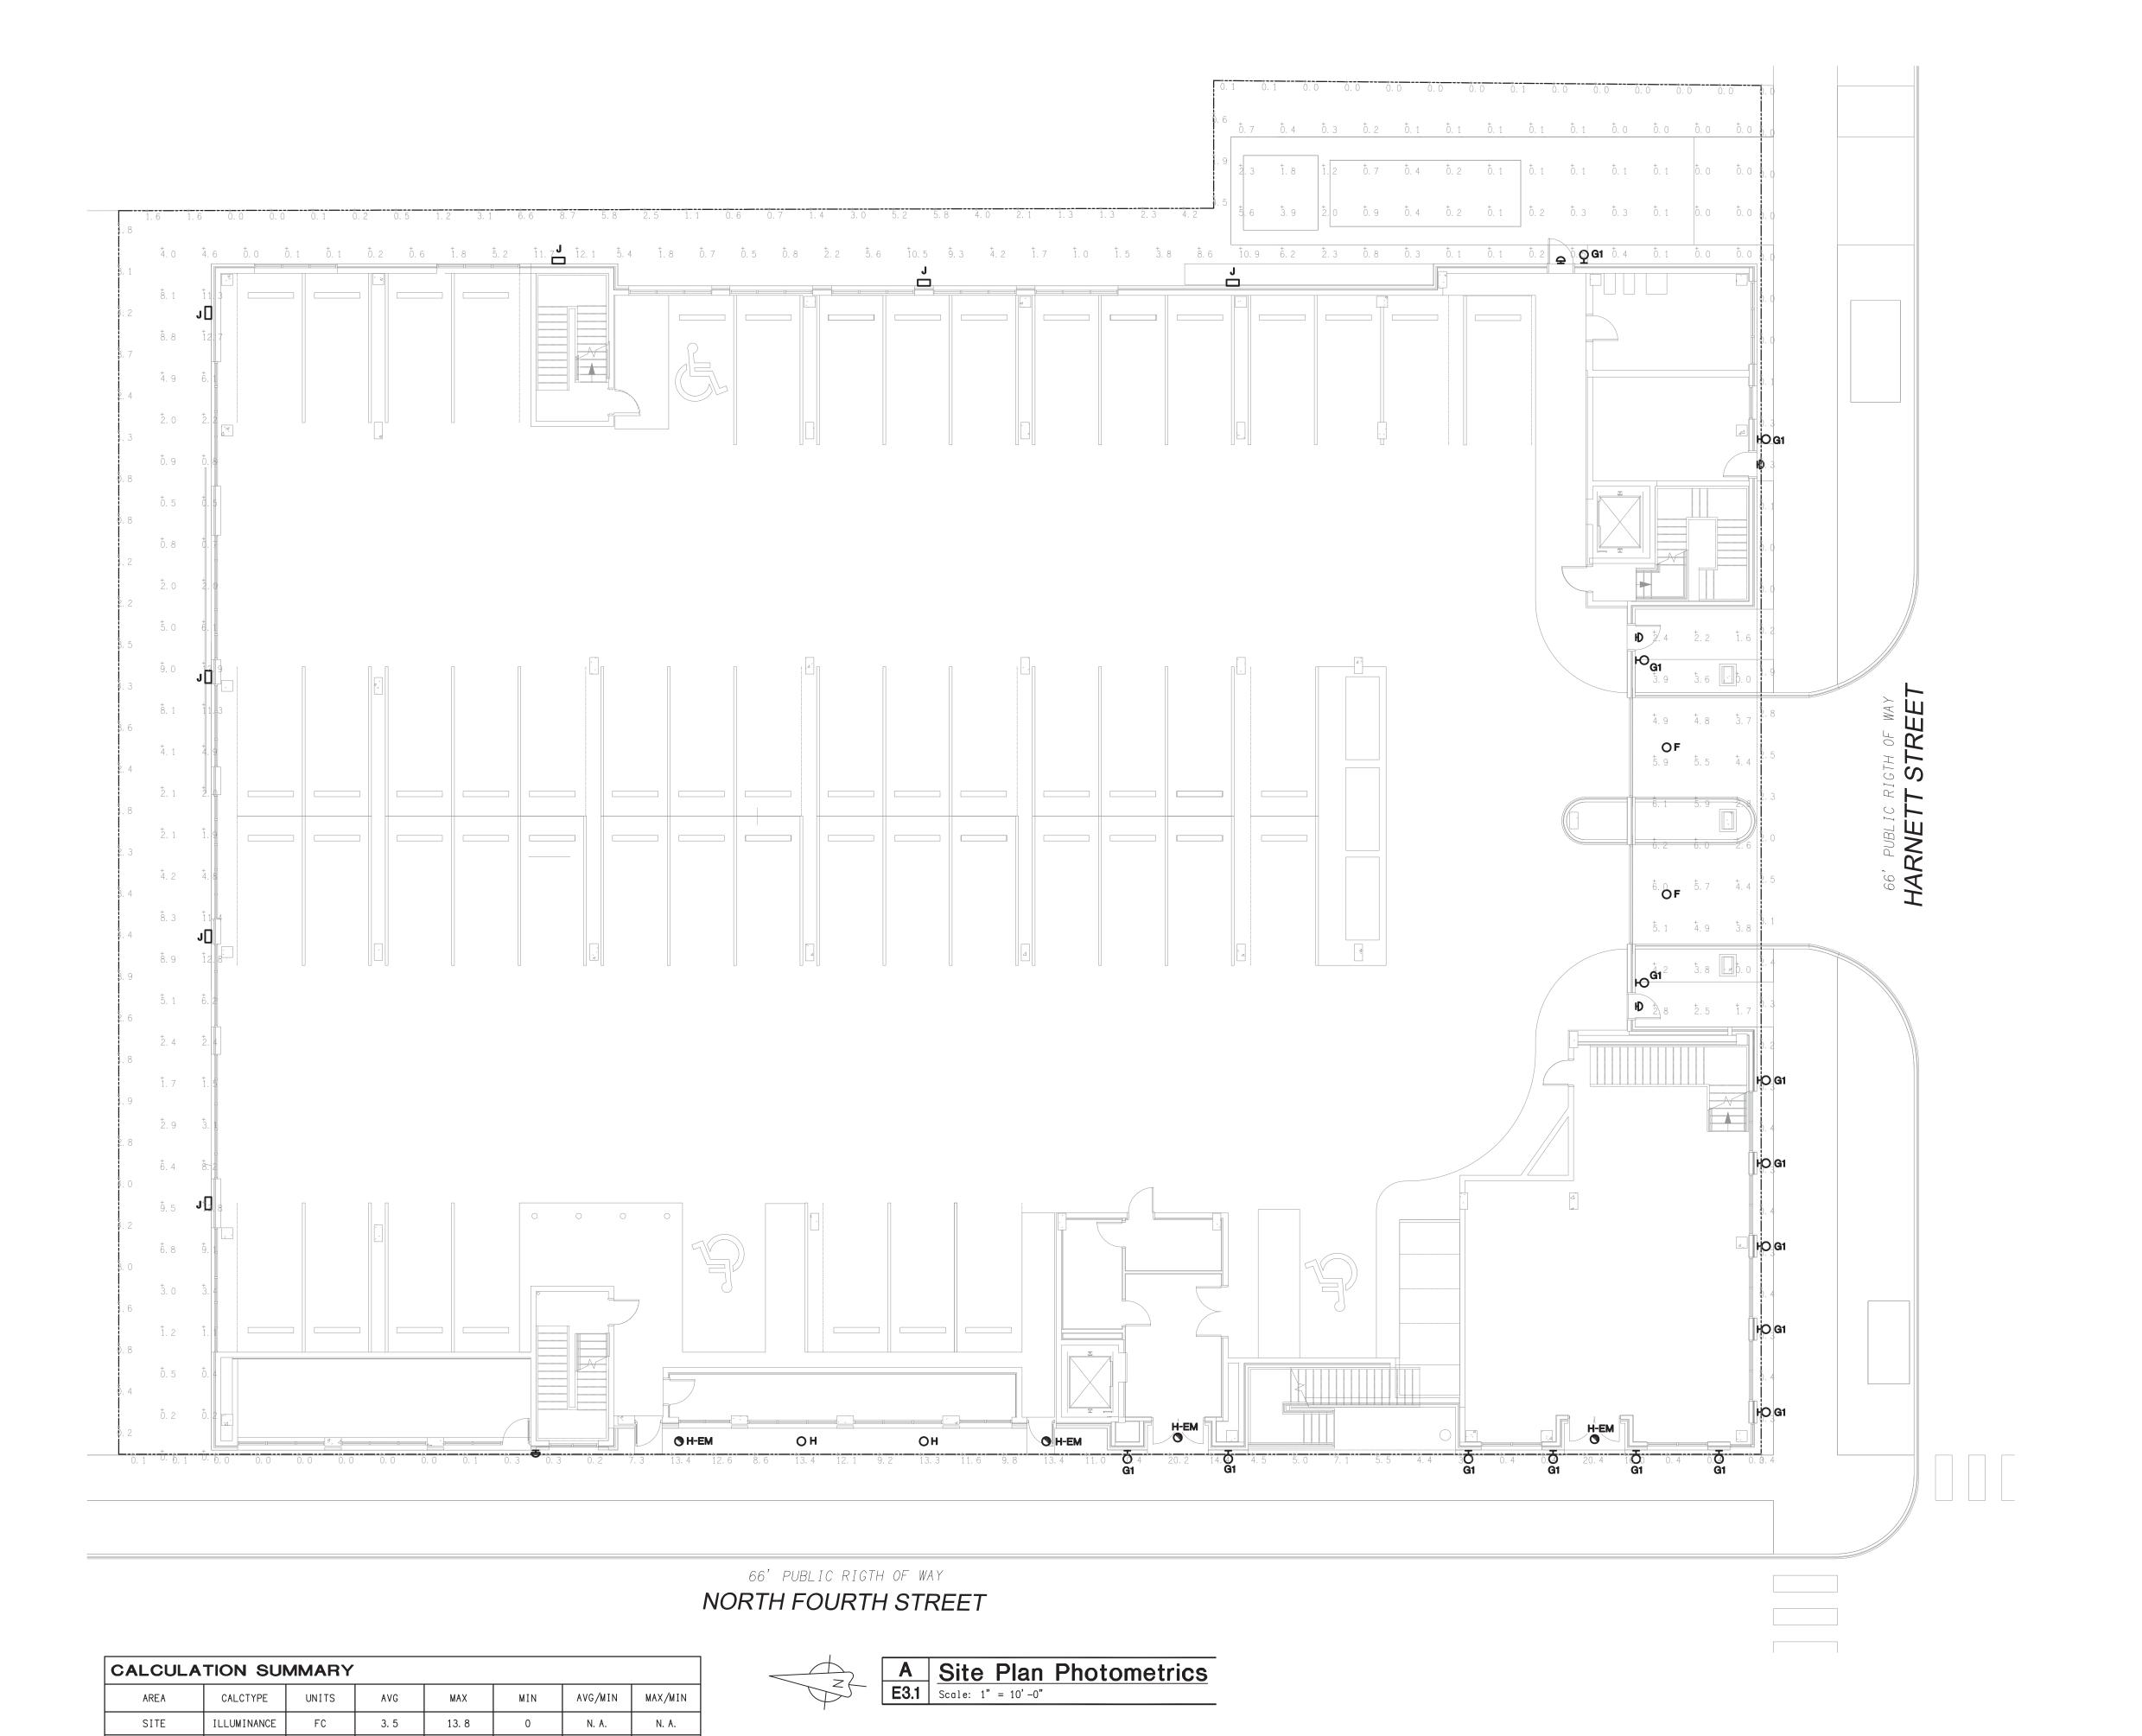

2. 8

20. 4

N. A.

PROPERTY LINE | ILLUMINANCE

© 2022 MARK LOUDERMILK ARCHITECTS, PLLC

MARK DATE DESCRIPTION

PROJECT NO: 22049

CAD DWG FILE:

DRAWN BY:

CHK'D BY:

Site Plan
Photometrics

MARK LOUDERMILK

201 N. FRONT ST. SUITE 1004 WILMINGTON, NORTH CAROLINA 28401

910.769.3583

12/07/2022

ENGINEERING

DAVID SIMS &
ASSOCIATES, P.C.
CONSULTING ENGINEERS

ARBORETUM CENTRE 108 GILES AVE, SUITE 100 WILMINGTON, NC 28403

910.791.8016 NC License: C-1150

www.dsaeng.com

1010 N 4TH STRE

E3.1